Merton Council Planning Applications Committee

10 December 2020

Supplementary agenda

11 Pollards Hill Estate, Mitcham 1 - 44

Application: 19/P4032 Ward: Pollards Hill

Recommendation: Grant Permission subject to conditions.

12 Land On South Side, Wyke Road, Raynes Park 45 - 80


Application: 20/P0945 Ward: Raynes Park

Recommendation: Grant planning permission subject to the

completion of a S106 agreement and conditions.



NORTHGATE SE GIS Print Template

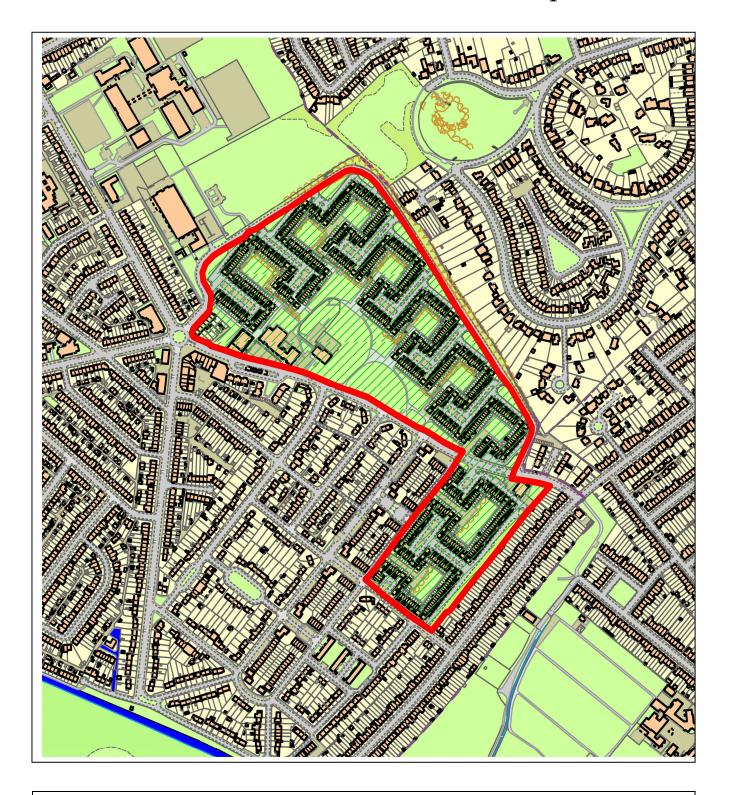

This material has been reproduced from Ordnance Survey digital map data with the permission of the controller of Her Majesty's Stationery Office, © Crown Copyright.









PROJEC1

POLLARDS HILL-REFUGE STORAGE WORKS

g ST

PLANNING

CLIENT

MOAT HOMES LIMITED,
MARINER HOUSE,
GALLEON BOULEVARD,
CROSSWAYS, KENT
DA2 6QE
CONSULTANT

AECOM ALDGATE TOWER, 2 LEMAN STREET, LONDON E1 8FA www.aecom.com

NOTES

THIS DRAWING IS TO BE READ IN CONJUNCTION WITH ALL OTHER RELEVANT DOCUMENTATION.
 DO NOT SCALE FROM THIS DRAWING, USE ONLY PRINTED DIMENSIONS.
 ALL DIMENSIONS IN MILLIMETRES, ALL CHAINAGES, LEVELS AND COORDINATES ARE IN METRES UNLESS DEFINED OTHERWISE.

4. THIS DRAWING IS TO BE READ IN CONJUNCTION WITH THE PROJECT HEALTH & SAFETY FILE FOR ANY IDENTIFIED POTENTIFIESKS.

5. THIS DRAWING MUST BE PRINTED IN COLOUR.

PLANNING APPLICATION

GM KT

RF VC 15/10/19 PL1

DRAFT PLANNING APPLICATION JC AC
FOR COMMENT
DESCRIPTION

DESCRIPTION

SA XX 22/05/19 PL0+6

Description

The street of t

SCALE 1:1250@A0

SCALE 1:1250@A0

PROJECT NUMBER

60519374

LOCATION PLAN

SHEET NUMBER

60519374_LOCATION_PLAN_001_REV_PL1







POLLARDS HILL-REFUGE STORAGE WORKS

PLANNING

MOAT HOMES LIMITED, MARINER HOUSE, GALLEON BOULEVARD, CROSSWAYS, KENT DA2 6QE

ALDGATE TOWER, 2 LEMAN STREET, LONDON E1 8FA www.aecom.com

CONSULTANT

 THIS DRAWING IS TO BE READ IN CONJUNCTION WITH ALL OTHER RELEVANT DOCUMENTATION.
 DO NOT SCALE FROM THIS DRAWING, USE ONLY PRINTED 3. ALL DIMENSIONS IN MILLIMETRES, ALL CHAINAGES, LEVELS
AND COORDINATES ARE IN METRES UNLESS DEFINED

4. THIS DRAWING IS TO BE READ IN CONJUNCTION WITH THE PROJECT HEALTH & SAFETY FILE FOR ANY IDENTIFIED POTENTIF

5. THIS DRAWING MUST BE PRINTED IN COLOUR.

ISSUE/REVISION

SCALE 1:1250@A0

PROJECT NUMBER

SHEET TITLE

LOCATION PLAN

60519374_LOCATION_PLAN_001_REV_PL2



ASSET MANAGEMENT

Aldgate Tower, 2 Leman Street, London, E1 8FA

PROJECT POLLARDS HILL REFUSE STORAGE WORKS

STAGE PLANNNING APPLICATION

Contract No:	6051	19374			PL1								
We enclose copies of the drawings listed below	N												
			Day	19							ī		
			Month	10									
			Year	20									
Drawing No.	Size	Drawing Title											
60519374 BERKSHIRE CLOSE 001	A0	BERKSHIRE CLOSE EXISTING SITE LAYOUT		PL1							П	\top	$\neg \neg$
60519374 BERKSHIRE CLOSE 002	A0	BERKSHIRE CLOSE PROPOSED BIN STORE LOCATIONS									\vdash	+	\dashv
60519374 BERKSHIRE CLOSE 003	A0	BERKSHIRE CLOSE PROPOSED SWEPT PATH ANALYSIS									-	+	+
60519374_BRECON CLOSE 001	A0	BRECON CLOSE EXISTING SITE LAYOUT									-	+	+
60519374_BRECON CLOSE_003	A0	BRECON CLOSE PROPOSED BIN STORE LOCATIONS									\leftarrow	+	-
60519374_BRECON CLOSE_004	A0	BRECON CLOSE PROPOSED SWEPT PATH ANALYSIS									\leftarrow	+	-
	A0										\vdash	+	+
60519374_CAENARVON CLOSE_001	A0	CAENARYON CLOSE EXISTING SITE LAYOUT									\vdash	+	-
60519374_CAENARVON CLOSE_002		CAENARVON CLOSE PROPOSED BIN STORE LOCATIONS									\vdash	+	-
60519374_CAENARVON CLOSE_003	A0	CAENARVON CLOSE PROPOSED SWEPT PATH ANALYSIS									\vdash	+	-
60519374_CHESHIRE CLOSE_001	A0	CHESHIRE CLOSE EXISTING SITE LAYOUT									\vdash	$\perp \perp \downarrow$	-
60519374_CHESHIRE CLOSE_002	A0	CHESHIRE CLOSE PROPOSED BIN STORE LOCATIONS									\vdash	\perp	\perp
60519374_CHESHIRE CLOSE_003	A0	CHESHIRE CLOSE PROPOSED SWEPT PATH ANALYSIS									\vdash	$\perp \perp \perp$	
60519374_GLAMORGAN CLOSE_001	A0	GLAMORGAN CLOSE EXISTING SITE LAYOUT									$\perp \perp$		
60519374_GLAMORGAN CLOSE_002	A0	GLAMORGAN CLOSE PROPOSED BIN STORE LOCATIONS		PL4							ш		
60519374_GLAMORGAN CLOSE_003	A0	GLAMORGAN CLOSE PROPOSED SWEPT PATH ANALYSIS		PL3									
60519374_HUNTINGDON CLOSE_001	A0	HUNTINGDON CLOSE EXISTING SITE LAYOUT		PL2							1		
60519374_HUNTINGDON CLOSE_002	A0	HUNTINGDON CLOSE PROPOSED BIN STORE LOCATIONS		PL4									
60519374 HUNTINGDON CLOSE 003	A0	HUNTINGDON CLOSE PROPOSED SWEPT PATH ANALYSIS		PL3									
60519374 KENT CLOSE 001	A0	KENT CLOSE EXISTING SITE LAYOUT		PL2							T		$\neg \neg$
60519374 KENT CLOSE 002	A0	KENT CLOSE PROPOSED BIN STORE LOCATIONS		PL4								\top	\neg
60519374_KENT CLOSE_003	A0	KENT CLOSE PROPOSED SWEPT PATH ANALYSIS									\vdash	+	\dashv
60519374 LINDSEY CLOSE 001	A0	LINDSEY CLOSE EXISTING SITE LAYOUT									-	+	+
60519374 LINDSEY CLOSE 002	A0	LINDSEY CLOSE PROPOSED BIN STORE LOCATIONS		PL4							\vdash	+	\dashv
60519374 LINDSEY CLOSE 003	A0	LINDSEY CLOSE PROPOSED SWEPT PATH ANALYSIS		PL3							\vdash	+	\dashv
60519374 LOCATION PLAN 001	A0	LOCATION PLAN									rt	\pm	\dashv
60519374 MONMOUTH CLOSE 001	A0	MONMOUTH CLOSE EXISTING SITE LAYOUT		PL1							rt	\pm	\dashv
60519374 MONMOUTH CLOSE 002	A0	MONMOUTH CLOSE PROPOSED BIN STORE LOCATIONS		PL1							rt	\pm	\dashv
60519374 MONMOUTH CLOSE 003	A0	MONMOUTH CLOSE PROPOSED SWEPT PATH ANALYSIS		PL1							rt	\pm	\dashv
60519374 MONTGOMERY CLOSE 001	A0	MONTGOMERY CLOSE EXISTING SITE LAYOUT		PL2							rt	\pm	\dashv
60519374_MONTGOMERY CLOSE_002	A0	MONTGOMERY CLOSE PROPOSED BIN STORE LOCATIONS		PL3							rt	\pm	\dashv
60519374 MONTGOMERY CLOSE 003	A0	MONTGOMERY CLOSE PROPOSED SWEPT PATH ANALYSIS										\pm	\neg
60519374 RADNOR CLOSE 001	A0	RADNOR CLOSE EXISTING SITE LAYOUT		PL2									\neg
60519374 RADNOR CLOSE 002	A0	RADNOR CLOSE PROPOSED BIN STORE LOCATIONS		PL2									\neg
60519374 RADNOR CLOSE 003	A0	RADNOR CLOSE PROPOSED SWEPT PATH ANALYSIS		PL2									\neg
60519374 SHROPSHIRE CLOSE 001	A0	SHROPSHIRE CLOSE EXISTING SITE LAYOUT		PL2								\top	\neg
60519374 SHROPSHIRE CLOSE 002	A0	SHROPSHIRE CLOSE PROPOSED BIN STORE LOCATIONS		PL3							T		$\neg \neg$
60519374 SHROPSHIRE CLOSE 003	A0	SHROPSHIRE CLOSE PROPOSED SWEPT PATH ANALYSIS		PL3							T		$\neg \neg$
60519374_SITE_PLAN_001	A0	EXISTING SITE PLAN		PL1							T		$\neg \neg$
60519374 SITE PLAN 002	A0	PROPOSED SITE PLAN		PL3									\neg
0001707 [_0112_1 21112_002	7.0	THO GOLD GILL DIN									rt	\pm	\dashv
											\sqcap	11	$\exists \exists$
						11					一	+	$\dashv \dashv$
											\sqcap	11	$\exists \exists$
						+					\sqcap	+	$\dashv \dashv$
I -	1	•		ı									
DISTRIBUTION													
	LOCA	L PLANNING AUTHORITY		E		TI					П	\top	\Box
	2007			-		+			++	-	\vdash	++	+
	-					+	-		++	-	\vdash	++	+
									1 1		\vdash	+	\dashv
	-					1 1			\vdash		\vdash	+	\dashv
T. Control of the Con	1			1	1 1	1 1	1	r I	1 1	1	. 1	1	1 1

DISTRIBUTION								
	LOCAL PLANNING AUTHORITY	Ε						
	Issue Status	Р						
	Issue By	GF						

Key



ASSET MANAGEMENT

Aldgate Tower, 2 Leman Street, London, E1 8FA

PROJECT POLLARDS HILL REFUSE STORAGE WORKS

STAGE PLANNNING APPLICATION

Contract No: 60519374 Sheet No: 1

•			Day	19								\Box
			Month	10								
			Year	20								
Drawing No.	Size	Drawing Title										
0519374 BERKSHIRE CLOSE 001	A0	BERKSHIRE CLOSE EXISTING SITE LAYOUT		PL1								\exists
00519374 BERKSHIRE CLOSE 002	A0	BERKSHIRE CLOSE PROPOSED BIN STORE LOCATIONS		PL2								\exists
0519374 BERKSHIRE CLOSE 003	A0	BERKSHIRE CLOSE PROPOSED SWEPT PATH ANALYSIS		PL2								\exists
50519374 BRECON CLOSE 001	A0	BRECON CLOSE EXISTING SITE LAYOUT		PL2								\exists
50519374_BRECON CLOSE_003	A0	BRECON CLOSE PROPOSED BIN STORE LOCATIONS		PL4								٦
60519374_BRECON CLOSE_004	A0	BRECON CLOSE PROPOSED SWEPT PATH ANALYSIS		PL3								٦
60519374_CAENARVON CLOSE_001	A0	CAENARVON CLOSE EXISTING SITE LAYOUT		PL2								\exists
60519374 CAENARVON CLOSE 002		CAENARVON CLOSE PROPOSED BIN STORE LOCATIONS		PL3								\exists
60519374 CAENARVON CLOSE 003		CAENARVON CLOSE PROPOSED SWEPT PATH ANALYSIS		PL3								\exists
60519374 CHESHIRE CLOSE 001		CHESHIRE CLOSE EXISTING SITE LAYOUT		PL3								\dashv
50519374_CHESHIRE CLOSE_002		CHESHIRE CLOSE PROPOSED BIN STORE LOCATIONS		PL4								\dashv
50519374 CHESHIRE CLOSE 003		CHESHIRE CLOSE PROPOSED SWEPT PATH ANALYSIS		PL3								\dashv
60519374 GLAMORGAN CLOSE 001		GLAMORGAN CLOSE EXISTING SITE LAYOUT		PL2								\exists
60519374_GLAMORGAN CLOSE_002		GLAMORGAN CLOSE PROPOSED BIN STORE LOCATIONS		PL4								\dashv
60519374_GLAMORGAN CLOSE_003		GLAMORGAN CLOSE PROPOSED SWEPT PATH ANALYSIS		PL3								\dashv
50519374 HUNTINGDON CLOSE 001		HUNTINGDON CLOSE EXISTING SITE LAYOUT		PL2								\exists
60519374 HUNTINGDON CLOSE 002		HUNTINGDON CLOSE PROPOSED BIN STORE LOCATIONS		PL4								\dashv
50519374 HUNTINGDON CLOSE 003		HUNTINGDON CLOSE PROPOSED SWEPT PATH ANALYSIS		PL3								\exists
50519374 KENT CLOSE 001		KENT CLOSE EXISTING SITE LAYOUT		PL2							+ +	٦
50519374_KENT CLOSE_002		KENT CLOSE PROPOSED BIN STORE LOCATIONS		PL4							+ +	٦
60519374_KENT CLOSE_003		KENT CLOSE PROPOSED SWEPT PATH ANALYSIS		PL3					 		+	\dashv
50519374_LINDSEY CLOSE_001		LINDSEY CLOSE EXISTING SITE LAYOUT		PL2							+ +	٦
60519374 LINDSEY CLOSE 002		LINDSEY CLOSE PROPOSED BIN STORE LOCATIONS		PL4								\exists
60519374_LINDSEY CLOSE_003	A0	LINDSEY CLOSE PROPOSED SWEPT PATH ANALYSIS		PL3								T
60519374_LOCATION_PLAN_001	A0	LOCATION PLAN		PL2								\exists
60519374_MONMOUTH CLOSE_001	A0	MONMOUTH CLOSE EXISTING SITE LAYOUT		PL1								٦
60519374_MONMOUTH CLOSE_002		MONMOUTH CLOSE PROPOSED BIN STORE LOCATIONS		PL1								
60519374_MONMOUTH CLOSE_003		MONMOUTH CLOSE PROPOSED SWEPT PATH ANALYSIS		PL1								
60519374_MONTGOMERY CLOSE_001		MONTGOMERY CLOSE EXISTING SITE LAYOUT		PL2								
60519374_MONTGOMERY CLOSE_002		MONTGOMERY CLOSE PROPOSED BIN STORE LOCATIONS		PL3					$\perp \perp$			
60519374_MONTGOMERY CLOSE_003		MONTGOMERY CLOSE PROPOSED SWEPT PATH ANALYSIS		PL3							\bot	_
60519374_RADNOR CLOSE_001		RADNOR CLOSE EXISTING SITE LAYOUT		PL2								_
60519374_RADNOR CLOSE_002		RADNOR CLOSE PROPOSED BIN STORE LOCATIONS		PL2								_
00519374_RADNOR CLOSE_003		RADNOR CLOSE PROPOSED SWEPT PATH ANALYSIS		PL2 PL2							+-	_
60519374_SHROPSHIRE CLOSE_001 60519374_SHROPSHIRE CLOSE_002		SHROPSHIRE CLOSE EXISTING SITE LAYOUT SHROPSHIRE CLOSE PROPOSED BIN STORE LOCATIONS		PL3					++		++	\dashv
60519374_SHROPSHIRE CLOSE_002		SHROPSHIRE CLOSE PROPOSED SIN STORE LOCATIONS SHROPSHIRE CLOSE PROPOSED SWEPT PATH ANALYSIS		PL3					++		++	-
50519374_SHROFSHIRE CEOSE_003 50519374_SITE_PLAN_001	A0	EXISTING SITE PLAN		PL1					\vdash		+	-
50519374_SITE_PLAN_002		PROPOSED SITE PLAN		PL3					+			\dashv
00317374_311E_1 EAIN_002	Au	TROI OSED SITE LEAN		1 23					+		+	\dashv
											+	\exists
											+	٦
												٦
												T
					•							
DISTRIBUTION												
	LOCAL	PLANNING AUTHORITY		E								
												٦
-									\vdash		+	\exists
					1				+		+	\dashv
					1				+		+	H
					+	+	+	+	+	+	++	\dashv

Key

E = E-Mail No. = Number of hard copies C = Contract
D = Digital Copy # = Orignal file format Z = As Built

Issue Status



POLLARDS HILL-REFUGE STORAGE WORKS

PLANNING

MOAT HOMES LIMITED, MARINER HOUSE, GALLEON BOULEVARD, CROSSWAYS, KENT DA2 6QE

AECOM ALDGATE TOWER, 2 LEMAN STREET, LONDON E1 8FA www.aecom.com

CONSULTANT

 THIS DRAWING IS TO BE READ IN CONJUNCTION WITH ALL OTHER RELEVANT DOCUMENTATION.
 DO NOT SCALE FROM THIS DRAWING, USE ONLY PRINTED DIMENSIONS.

3. ALL DIMENSIONS IN MILLIMETRES, ALL CHAINAGES, LEVELS
AND COORDINATES ARE IN METRES UNLESS DEFINED 4. THIS DRAWING IS TO BE READ IN CONJUNCTION WITH THE PROJECT HEALTH & SAFETY FILE FOR ANY IDENTIFIED POTENTIA

5. THIS DRAWING MUST BE PRINTED IN COLOUR.

ISSUE/REVISION

SCALE 1:1000@A0

PROJECT NUMBER

EXISTING SITE PLAN

60519374_SITE_PLAN_001_REV_PL1



A_COM

PROJE

POLLARDS HILL-REFUGE STORAGE WORKS

ဥ ST

PLANNING

CLIENT

MOAT HOMES LIMITED, MARINER HOUSE, GALLEON BOULEVARD, CROSSWAYS, KENT DA2 6QE

CONSULTANT

AECOM ALDGATE TOWER, 2 LEMAN STREET, LONDON E1 8FA www.aecom.com

NOTES

THIS DRAWING IS TO BE READ IN CONJUNCTION WITH ALL OTHER RELEVANT DOCUMENTATION.
 DO NOT SCALE FROM THIS DRAWING, USE ONLY PRINTED DIMENSIONS.
 ALL DIMENSIONS IN MILLIMETRES, ALL CHAINAGES, LEVELS AND COORDINATES ARE IN METRES UNLESS DEFINED

OTHERWISE.

4. THIS DRAWING IS TO BE READ IN CONJUNCTION WITH THE PROJECT HEALTH & SAFETY FILE FOR ANY IDENTIFIED POTENTIAL RISKS.

RISKS.
5. THIS DRAWING MUST BE PRINTED IN COLOUR.

PLANNING APPLICATION BIN STORE GF
& PARKING LOCATION REVIEW
PLANNING APPLICATION
BIN STORE POSITION REVIEW
PLANNING APPLICATION
PLANNING APPLICATION
BIN STORE POSITION REVIEW
PLANNING APPLICATION
BIN STORE POSITION GM KT

RF VC 15/10/19 PLC

DRAFT PLANNING APPLICATION JC AC
FOR COMMENT
DESCRIPTION

RF VC 15/10/19 PLC

SA XX 22/05/19 PLC

TOTAL TOTAL CREATER TO SERVICE ACC

FOR COMMENT
DESCRIPTION

ISSUE/REVISION

SCALE 1:1000@A0

SCALE 1:1000@A0

PROJECT NUMBER

60519374


SHEET TITLE

PROPOSED SITE PLAN

SHEET NUMBER

60519374_SITE_PLAN_002_REV_PL3



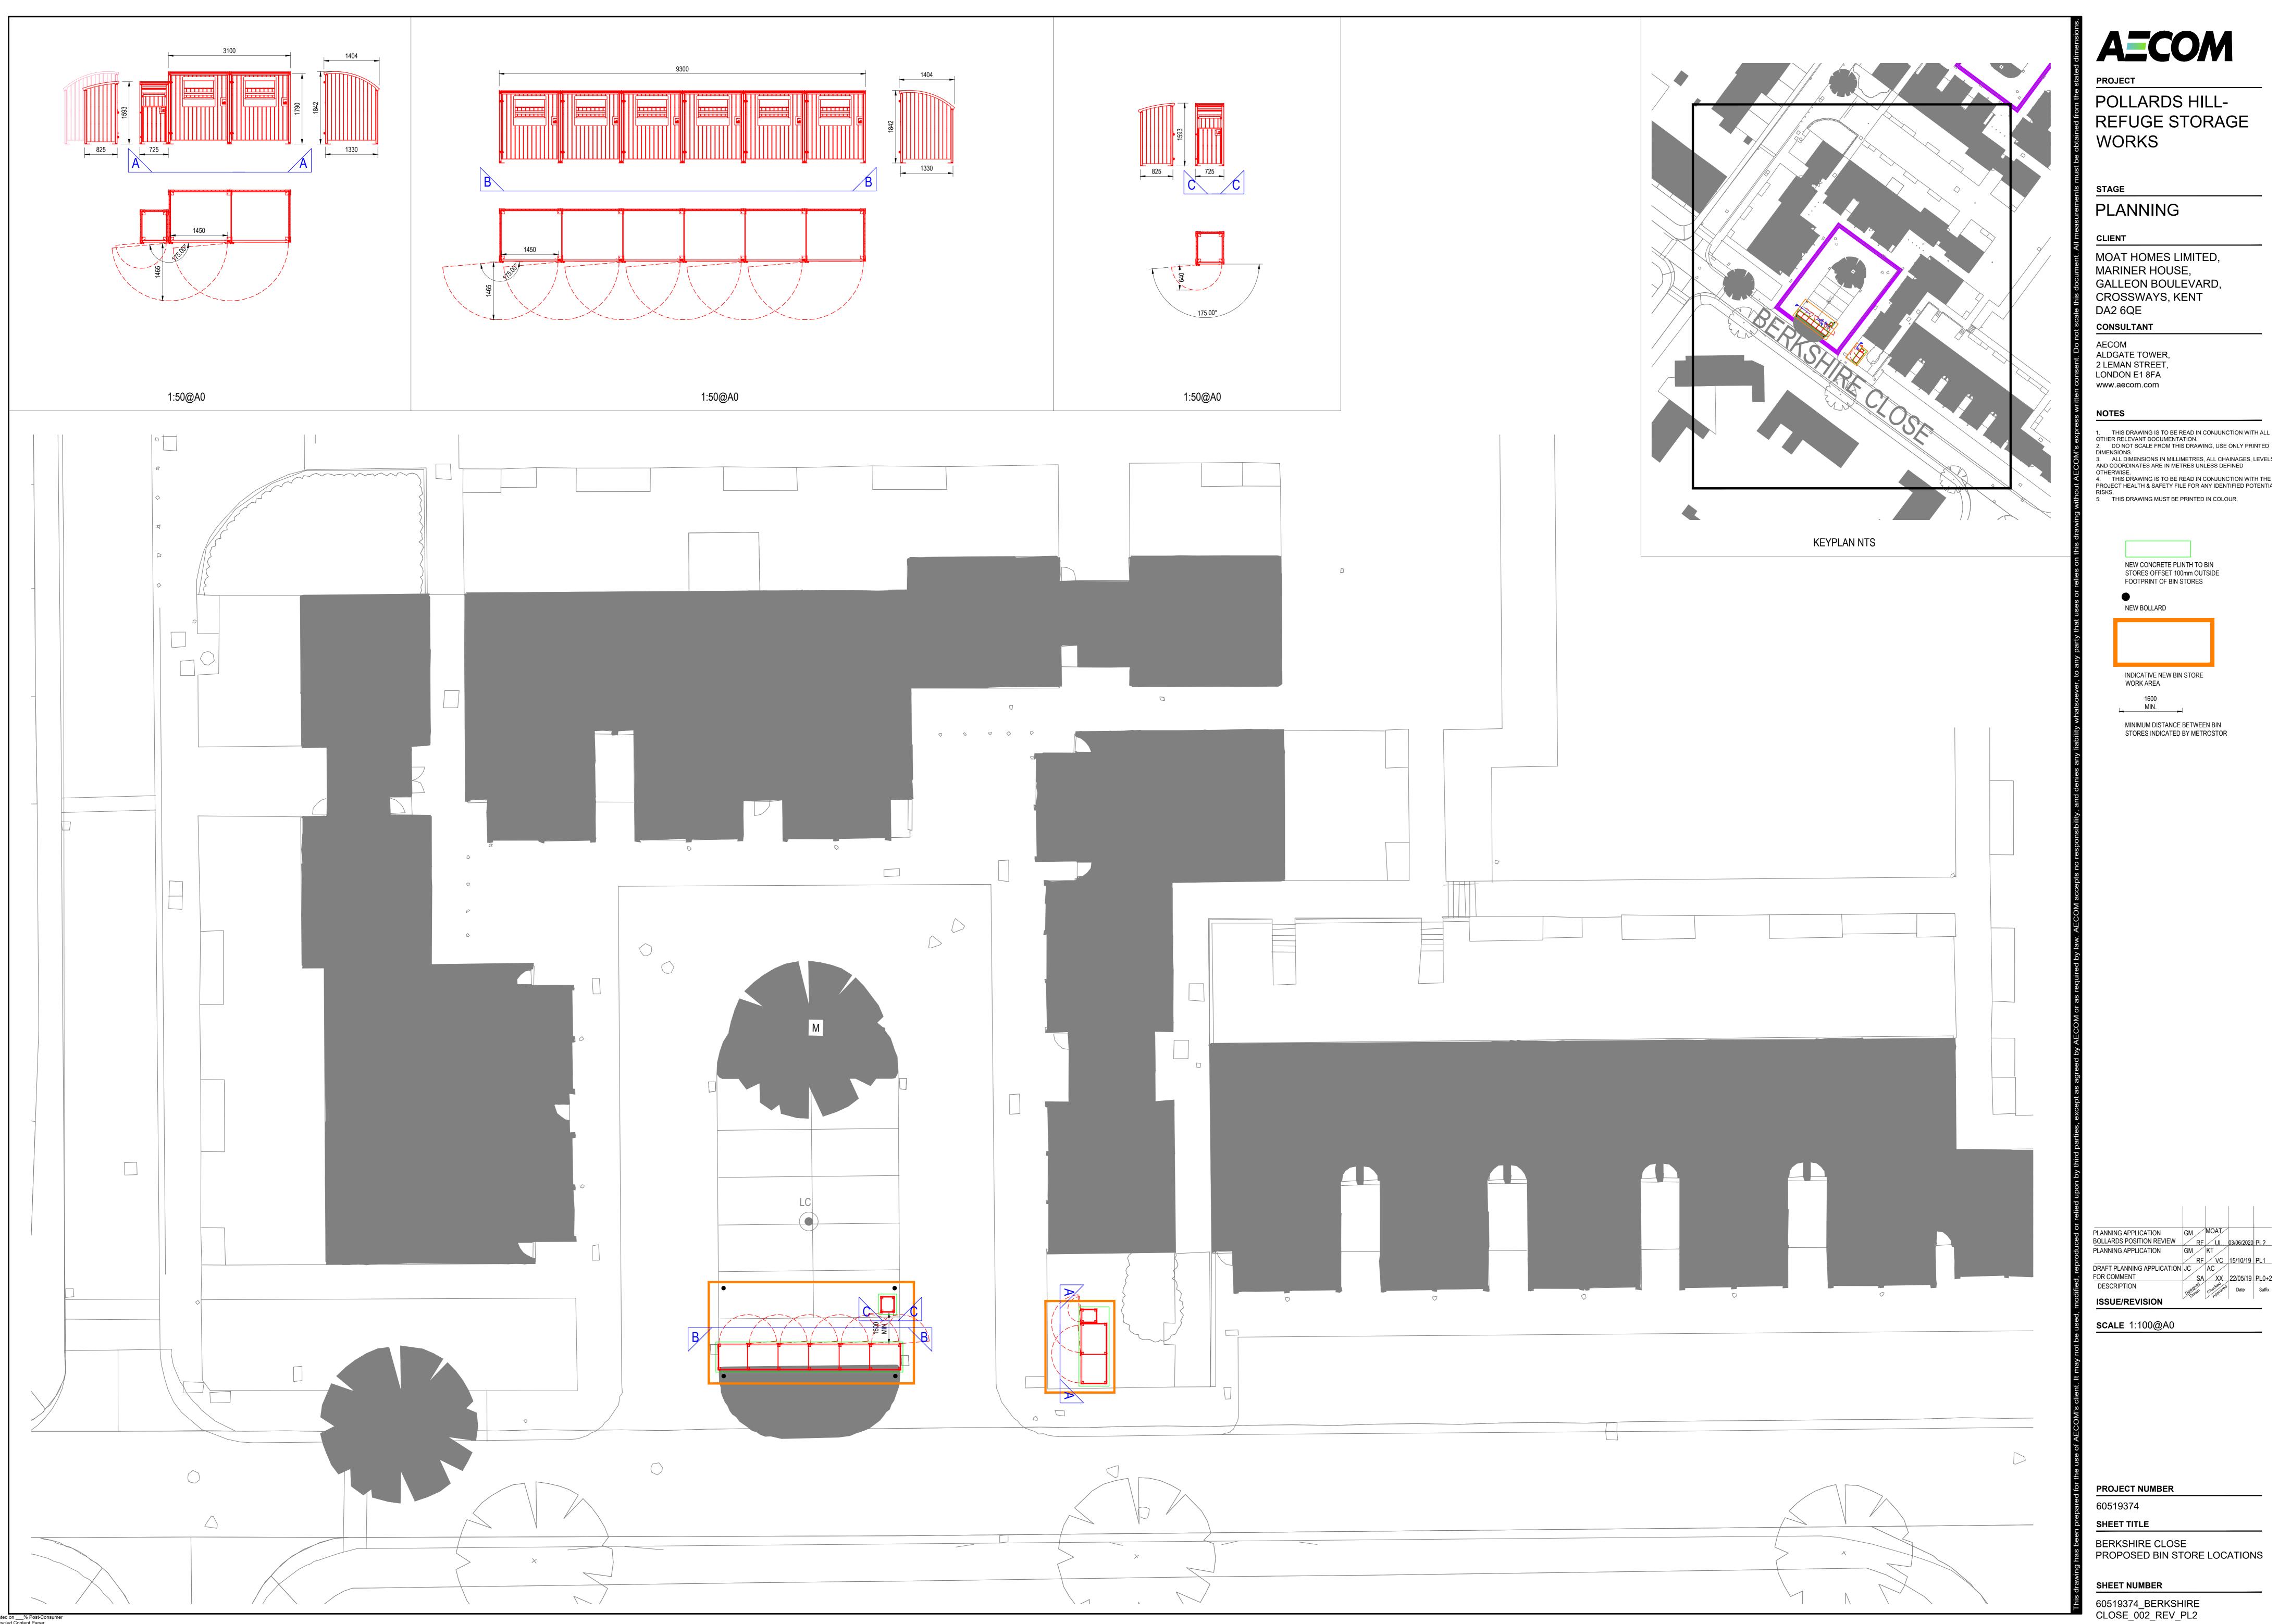

MOAT HOMES LIMITED, MARINER HOUSE, GALLEON BOULEVARD, CROSSWAYS, KENT

ALDGATE TOWER,

 THIS DRAWING IS TO BE READ IN CONJUNCTION WITH ALL OTHER RELEVANT DOCUMENTATION.
 DO NOT SCALE FROM THIS DRAWING, USE ONLY PRINTED 3. ALL DIMENSIONS IN MILLIMETRES, ALL CHAINAGES, LEVELS AND COORDINATES ARE IN METRES UNLESS DEFINED

5. THIS DRAWING MUST BE PRINTED IN COLOUR.

NEW CONCRETE PLINTH TO BIN STORES OFFSET 100mm OUTSIDE FOOTPRINT OF BIN STORES

NEW BOLLARD

INDICATIVE NEW BIN STORE WORK AREA


MINIMUM DISTANCE BETWEEN BIN STORES INDICATED BY METROSTOR

BOLLARDS POSITION REVIEW RF UL 03/06/2020 PL2
PLANNING APPLICATION GM KT DRAFT PLANNING APPLICATION JC AC FOR COMMENT SA XX 22/(
DESCRIPTION CARPOR CORPORATION DESCRIPTION

SCALE 1:100@A0

BERKSHIRE CLOSE PROPOSED BIN STORE LOCATIONS

60519374_BERKSHIRE CLOSE_002_REV_PL2

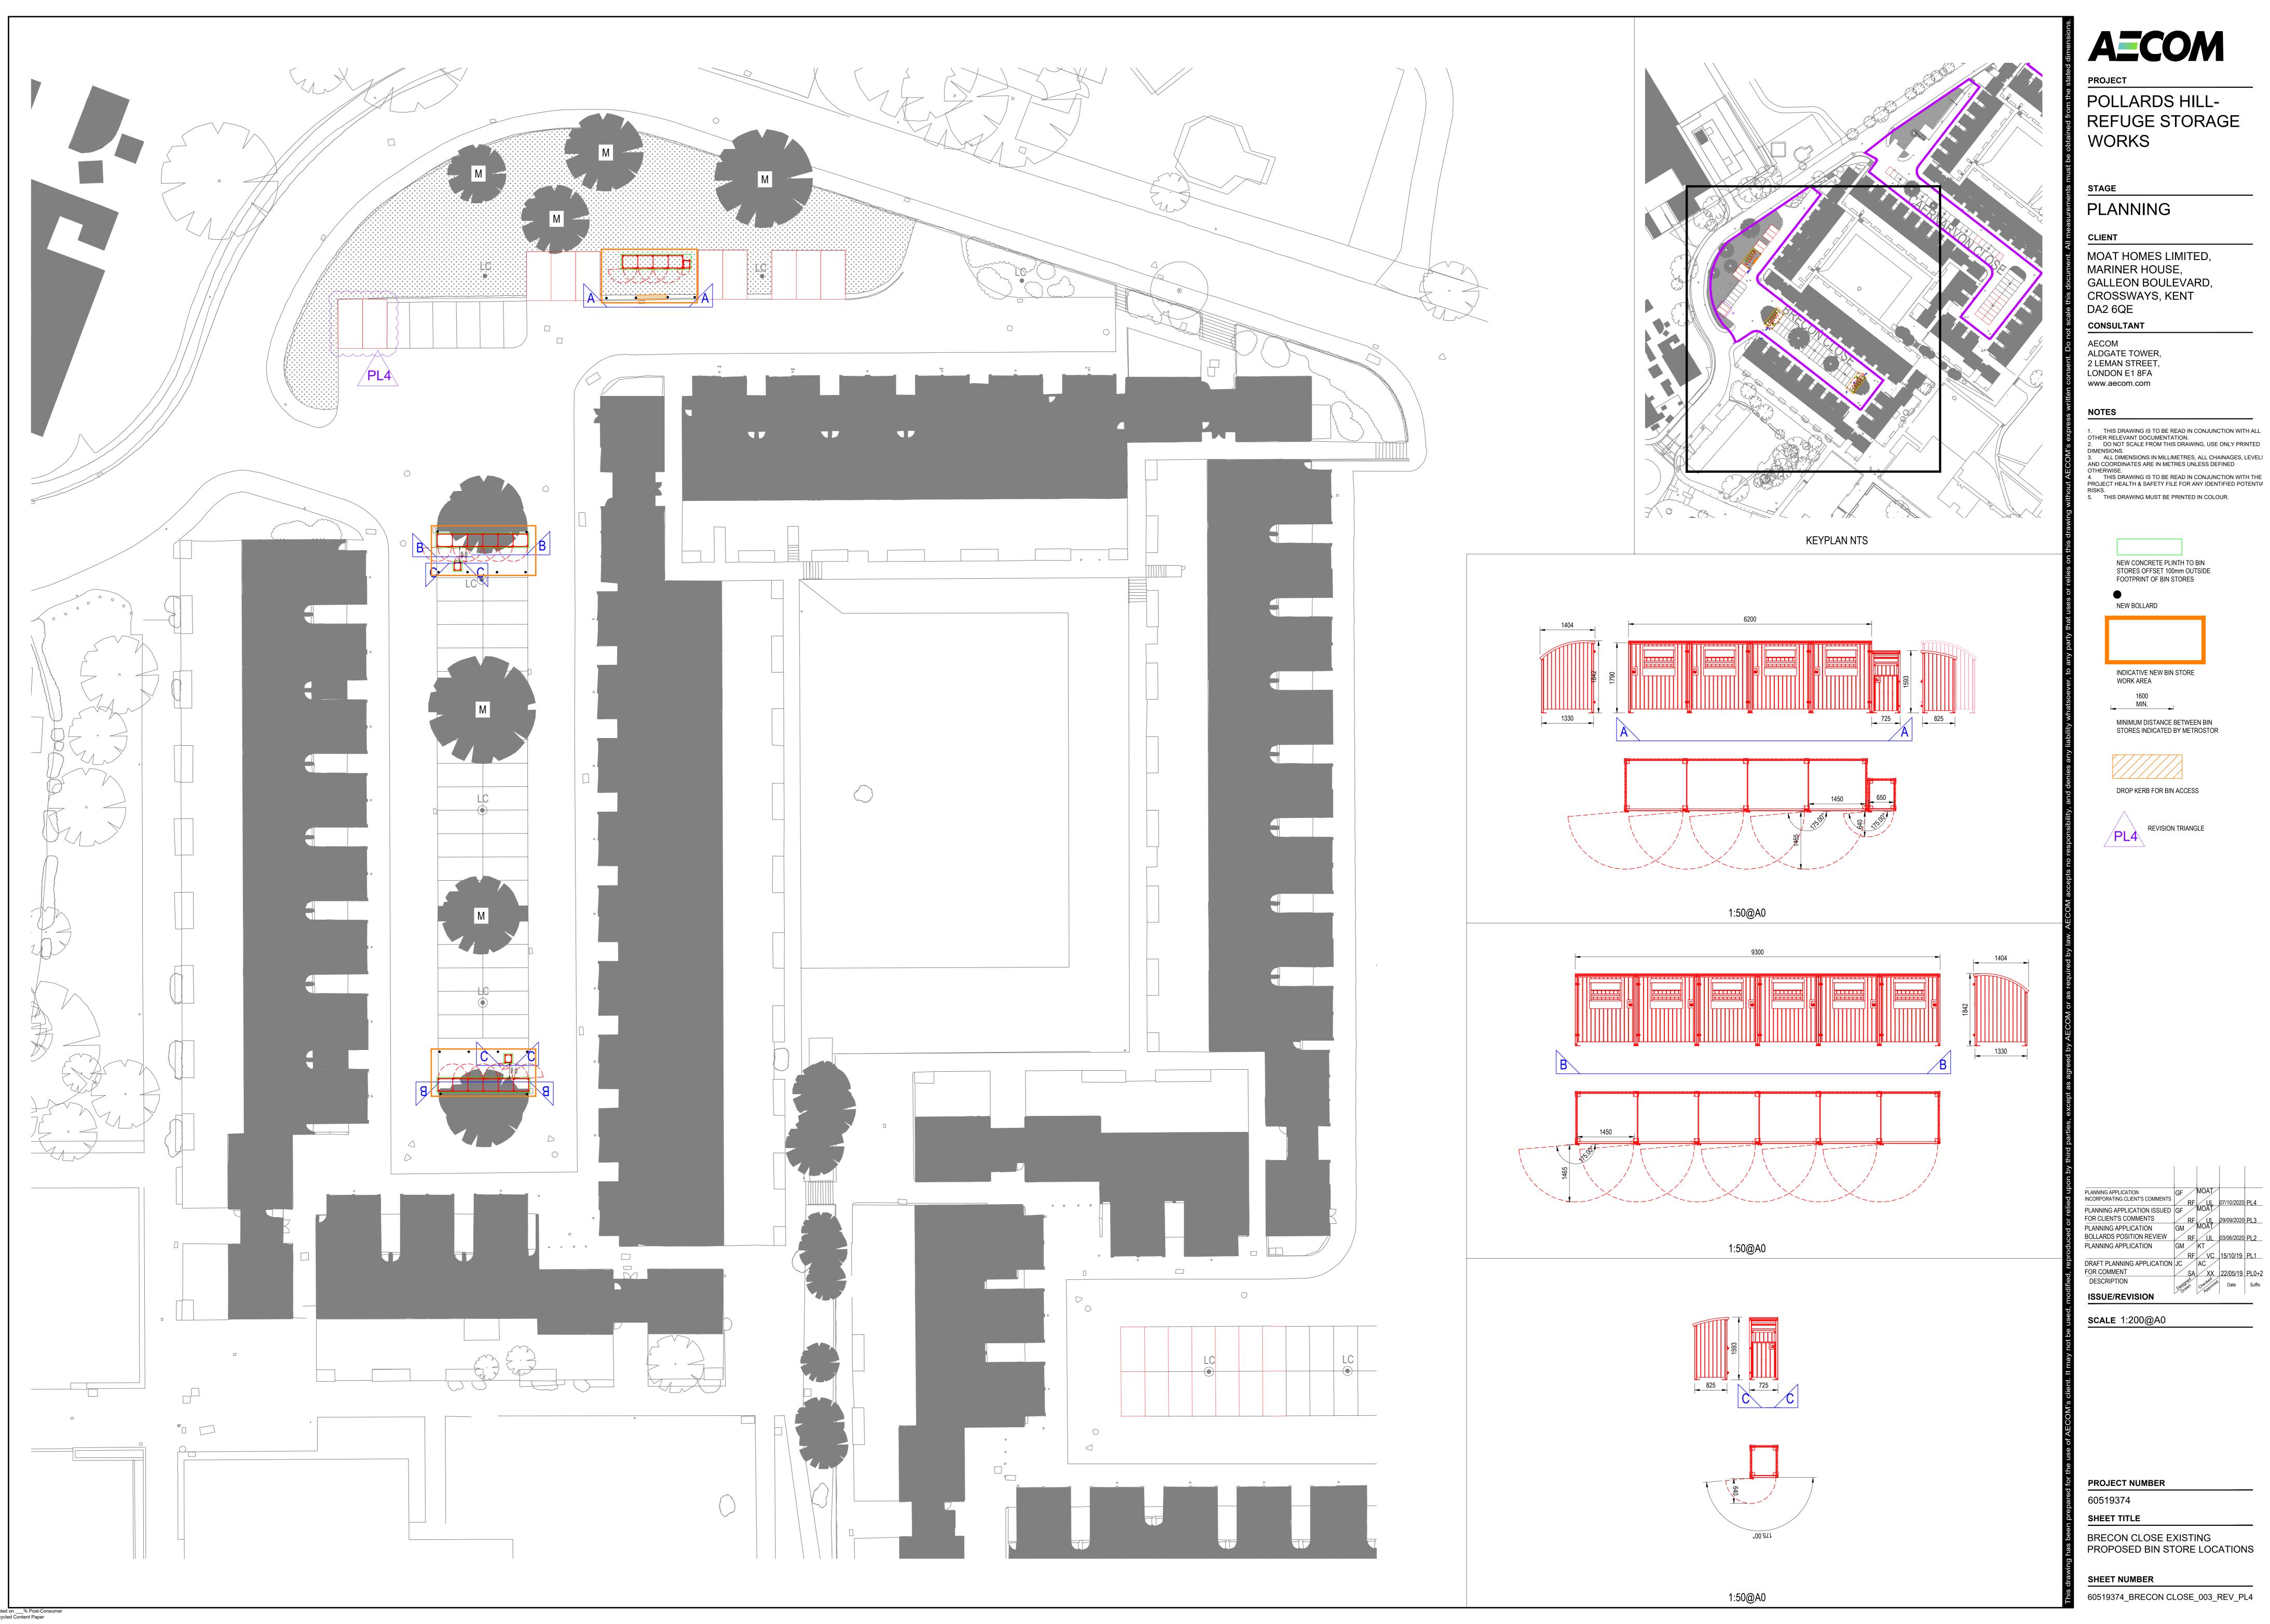

POLLARDS HILL-REFUGE STORAGE WORKS

PLANNING

MOAT HOMES LIMITED, MARINER HOUSE, GALLEON BOULEVARD, CROSSWAYS, KENT DA2 6QE

ALDGATE TOWER, 2 LEMAN STREET, LONDON E1 8FA

 THIS DRAWING IS TO BE READ IN CONJUNCTION WITH ALL OTHER RELEVANT DOCUMENTATION.
 DO NOT SCALE FROM THIS DRAWING, USE ONLY PRINTED 3. ALL DIMENSIONS IN MILLIMETRES, ALL CHAINAGES, LEVELS
AND COORDINATES ARE IN METRES UNLESS DEFINED

5. THIS DRAWING MUST BE PRINTED IN COLOUR.

NEW CONCRETE PLINTH TO BIN STORES OFFSET 100mm OUTSIDE FOOTPRINT OF BIN STORES NEW BOLLARD

INDICATIVE NEW BIN STORE WORK AREA

MINIMUM DISTANCE BETWEEN BIN STORES INDICATED BY METROSTOR

DROP KERB FOR BIN ACCESS

PLANNING APPLICATION INCORPORATING CLIENT'S COMMENTS BOLLARDS POSITION REVIEW RF UL 03/06/2020 PL2
PLANNING APPLICATION GM KT

ISSUE/REVISION

SCALE 1:200@A0


PROJECT NUMBER

SHEET TITLE

BRECON CLOSE EXISTING PROPOSED BIN STORE LOCATIONS

SHEET NUMBER

60519374_BRECON CLOSE_003_REV_PL4

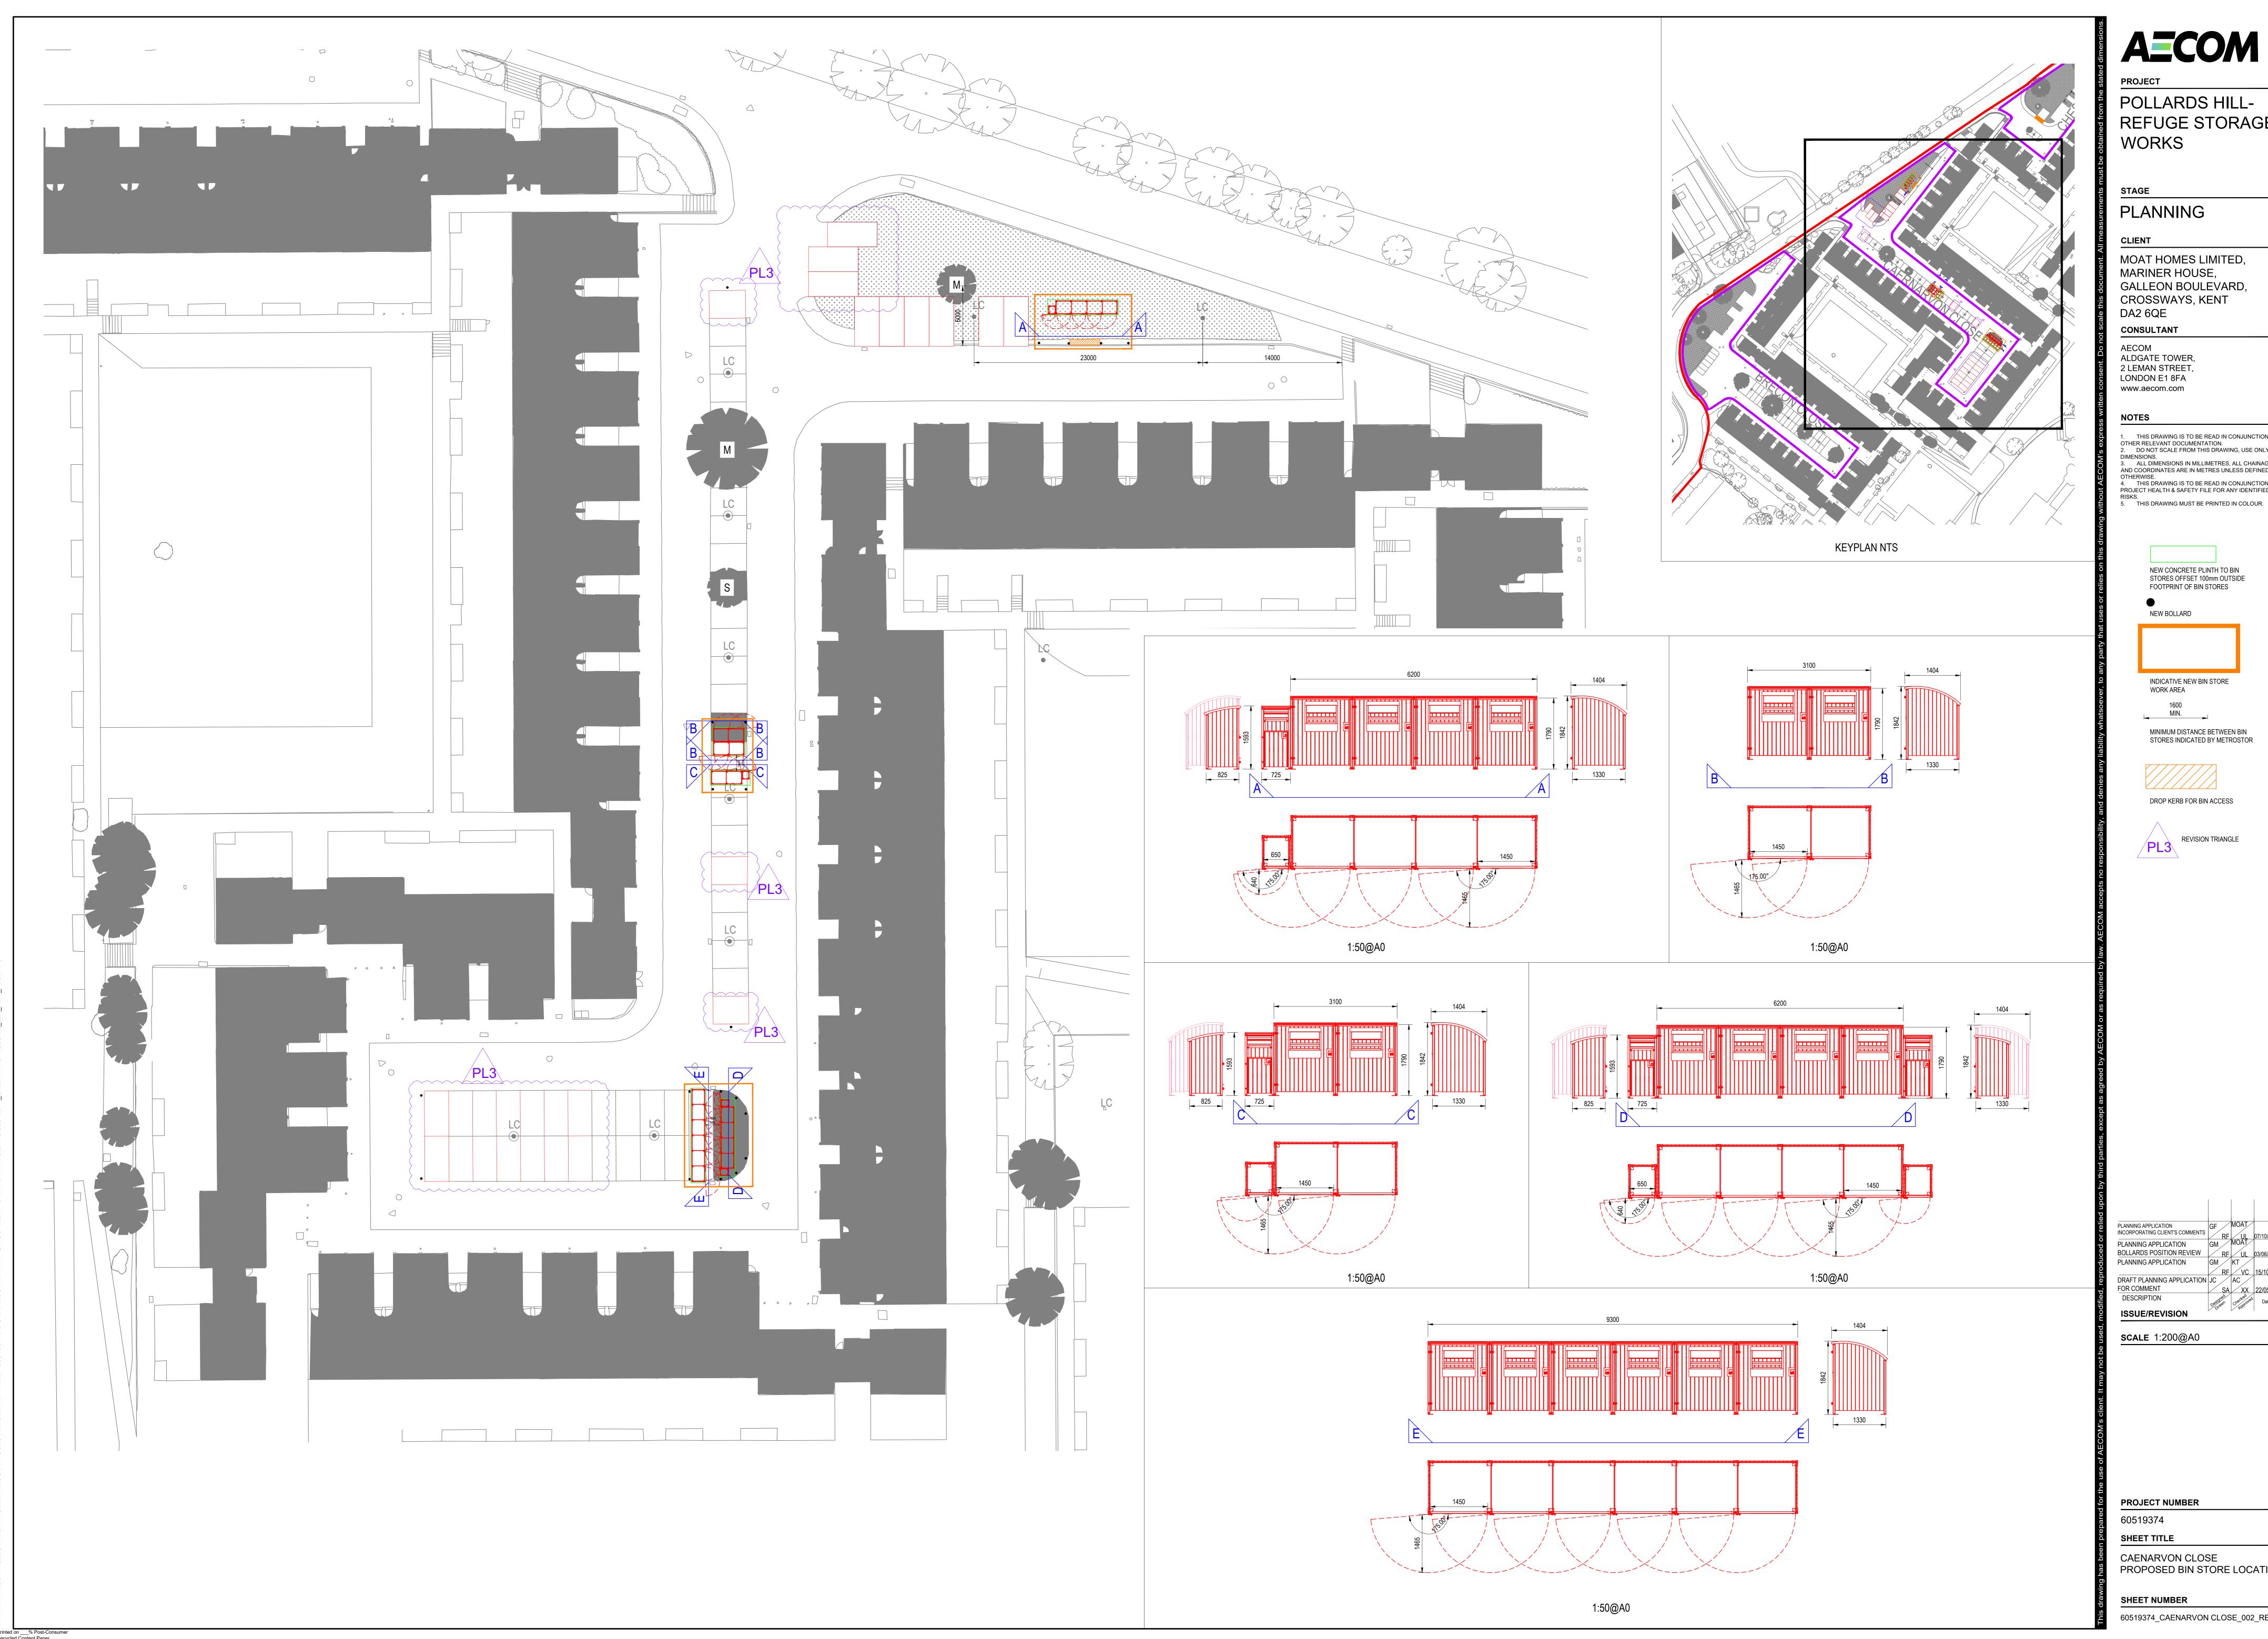

PLANNING

MOAT HOMES LIMITED, MARINER HOUSE, GALLEON BOULEVARD, CROSSWAYS, KENT

ALDGATE TOWER, 2 LEMAN STREET, LONDON E1 8FA

 THIS DRAWING IS TO BE READ IN CONJUNCTION WITH ALL OTHER RELEVANT DOCUMENTATION.
 DO NOT SCALE FROM THIS DRAWING, USE ONLY PRINTED 3. ALL DIMENSIONS IN MILLIMETRES, ALL CHAINAGES, LEVELS
AND COORDINATES ARE IN METRES UNLESS DEFINED 4. THIS DRAWING IS TO BE READ IN CONJUNCTION WITH THE PROJECT HEALTH & SAFETY FILE FOR ANY IDENTIFIED POTENTIF



INDICATIVE NEW BIN STORE WORK AREA

DROP KERB FOR BIN ACCESS


BOLLARDS POSITION REVIEW RF UL 03/06/2020 PL2
PLANNING APPLICATION GM KT

ISSUE/REVISION

SCALE 1:200@A0

CAENARVON CLOSE PROPOSED BIN STORE LOCATIONS

60519374_CAENARVON CLOSE_002_REV_PL3

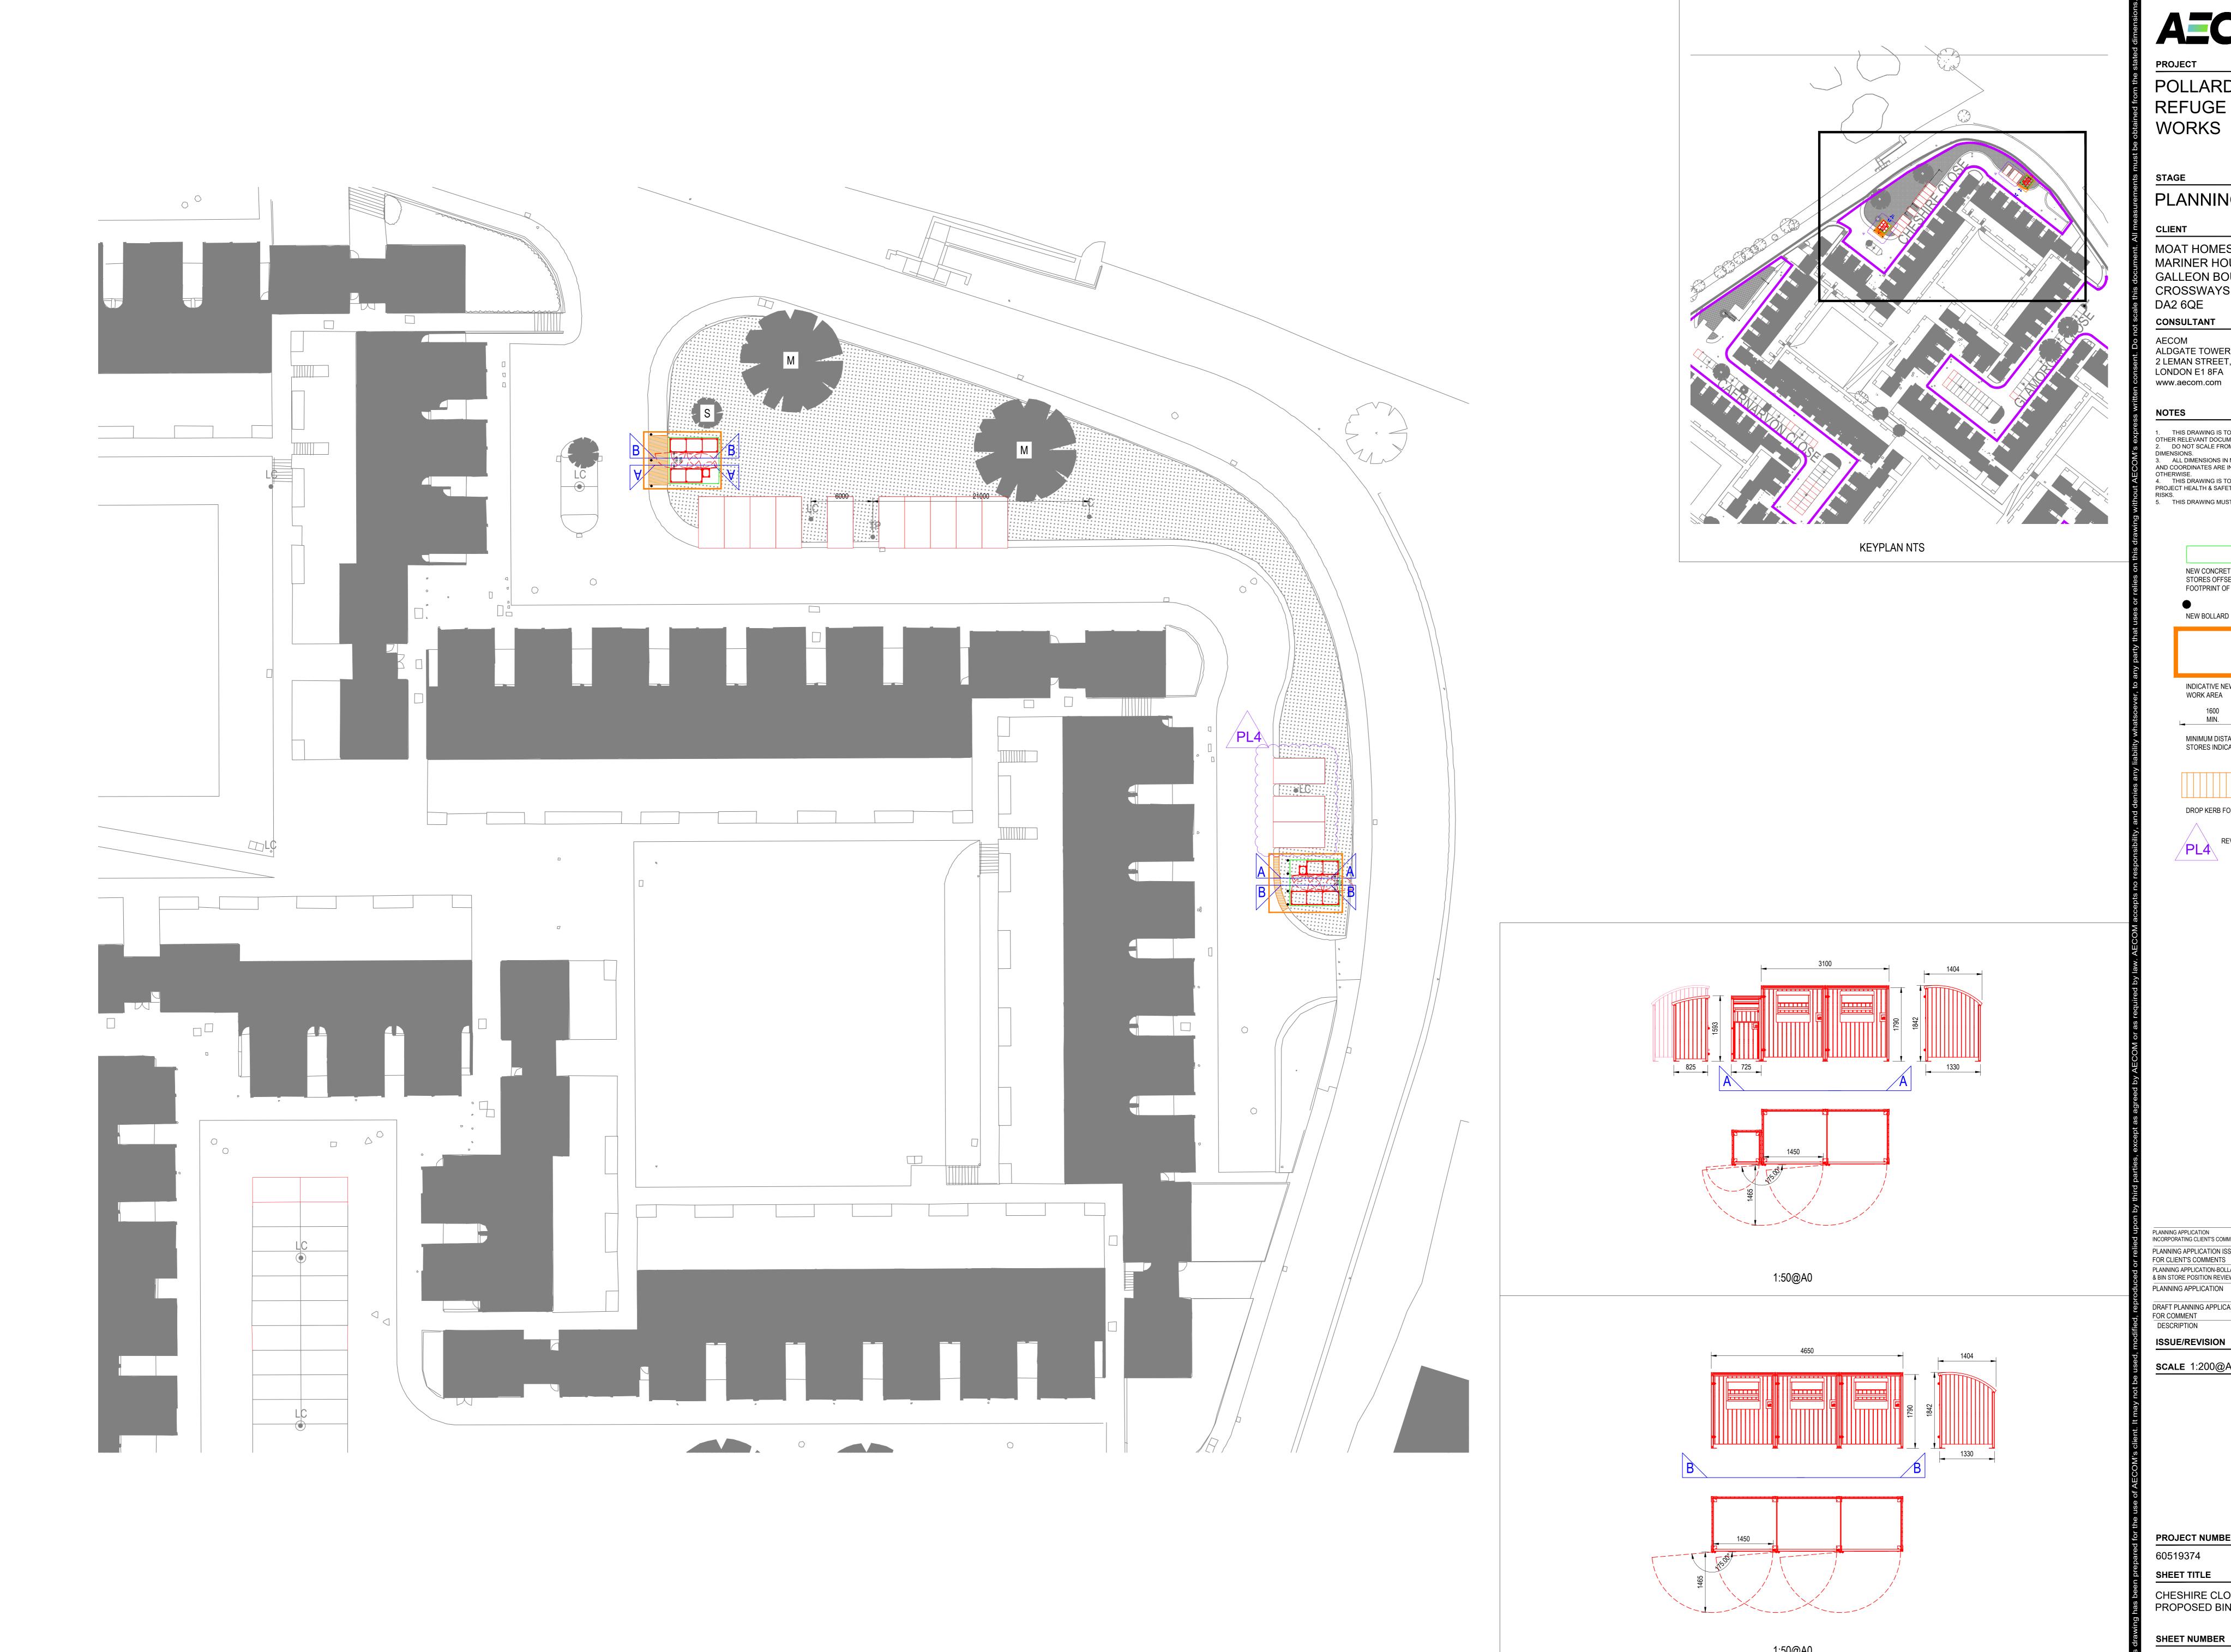

PLANNING

MOAT HOMES LIMITED, MARINER HOUSE, GALLEON BOULEVARD, CROSSWAYS, KENT DA2 6QE

AECOM ALDGATE TOWER, 2 LEMAN STREET, LONDON E1 8FA

 THIS DRAWING IS TO BE READ IN CONJUNCTION WITH ALL OTHER RELEVANT DOCUMENTATION.
 DO NOT SCALE FROM THIS DRAWING, USE ONLY PRINTED 3. ALL DIMENSIONS IN MILLIMETRES, ALL CHAINAGES, LEVELS
AND COORDINATES ARE IN METRES UNLESS DEFINED 4. THIS DRAWING IS TO BE READ IN CONJUNCTION WITH THE PROJECT HEALTH & SAFETY FILE FOR ANY IDENTIFIED POTENTIF


5. THIS DRAWING MUST BE PRINTED IN COLOUR.





WORK AREA

MINIMUM DISTANCE BETWEEN BIN STORES INDICATED BY METROSTOR

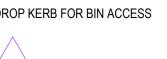

PLANNING APPLICATION INCORPORATING CLIENT'S COMMENTS PLANNING APPLICATION

ISSUE/REVISION


SCALE 1:200@A0

PROJECT NUMBER

60519374

CHESHIRE CLOSE PROPOSED BIN STORE LOCATIONS

60519374_CHESHIRE CLOSE_002_REV_PL4

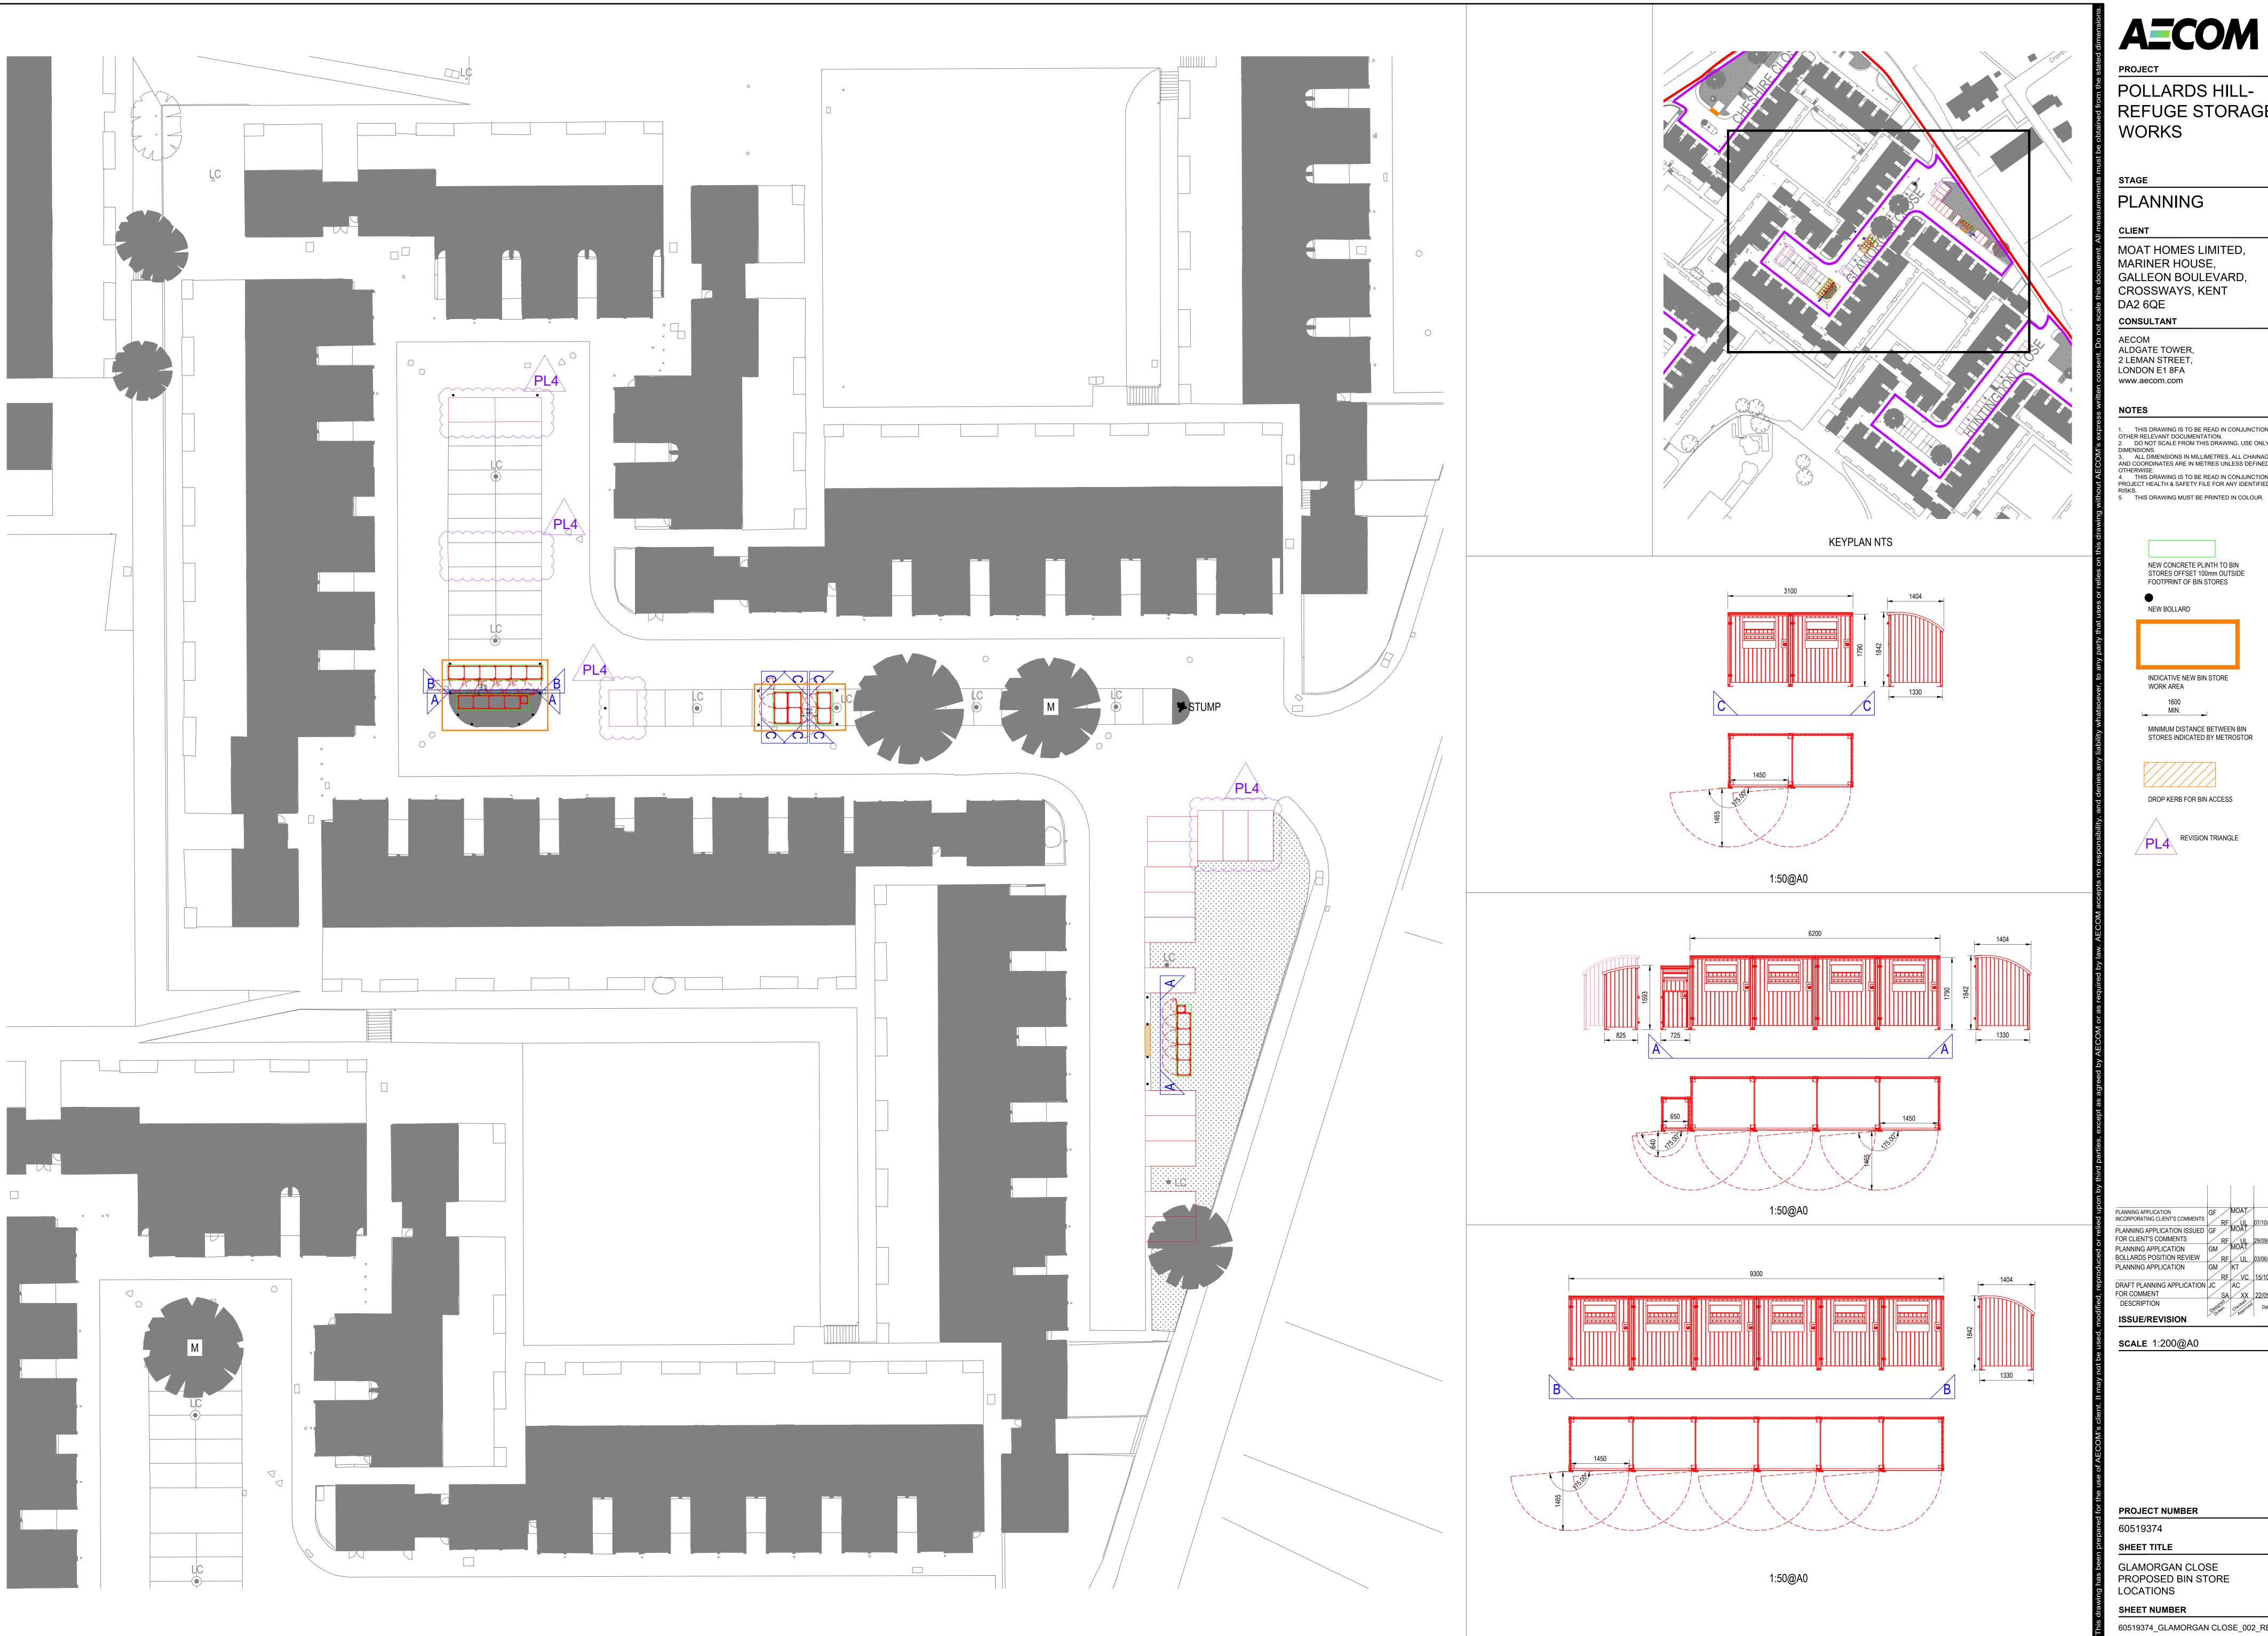

POLLARDS HILL-REFUGE STORAGE WORKS

PLANNING

MOAT HOMES LIMITED, MARINER HOUSE, GALLEON BOULEVARD, CROSSWAYS, KENT DA2 6QE

ALDGATE TOWER, 2 LEMAN STREET, LONDON E1 8FA

 THIS DRAWING IS TO BE READ IN CONJUNCTION WITH ALL OTHER RELEVANT DOCUMENTATION.
 DO NOT SCALE FROM THIS DRAWING, USE ONLY PRINTED 3. ALL DIMENSIONS IN MILLIMETRES, ALL CHAINAGES, LEVELS
AND COORDINATES ARE IN METRES UNLESS DEFINED 4. THIS DRAWING IS TO BE READ IN CONJUNCTION WITH THE PROJECT HEALTH & SAFETY FILE FOR ANY IDENTIFIED POTENTIF

> NEW CONCRETE PLINTH TO BIN STORES OFFSET 100mm OUTSIDE FOOTPRINT OF BIN STORES **NEW BOLLARD**

INDICATIVE NEW BIN STORE WORK AREA

MINIMUM DISTANCE BETWEEN BIN STORES INDICATED BY METROSTOR

DROP KERB FOR BIN ACCESS

PLANNING APPLICATION INCORPORATING CLIENT'S COMMENTS BOLLARDS POSITION REVIEW RF UL 03/06/2020 PL2
PLANNING APPLICATION GM KT DRAFT PLANNING APPLICATION JC AC 15/10/19 PL1 FOR COMMENT DESCRIPTION

SCALE 1:200@A0


PROJECT NUMBER

60519374 SHEET TITLE

GLAMORGAN CLOSE PROPOSED BIN STORE

LOCATIONS

SHEET NUMBER 60519374_GLAMORGAN CLOSE_002_REV_PL4

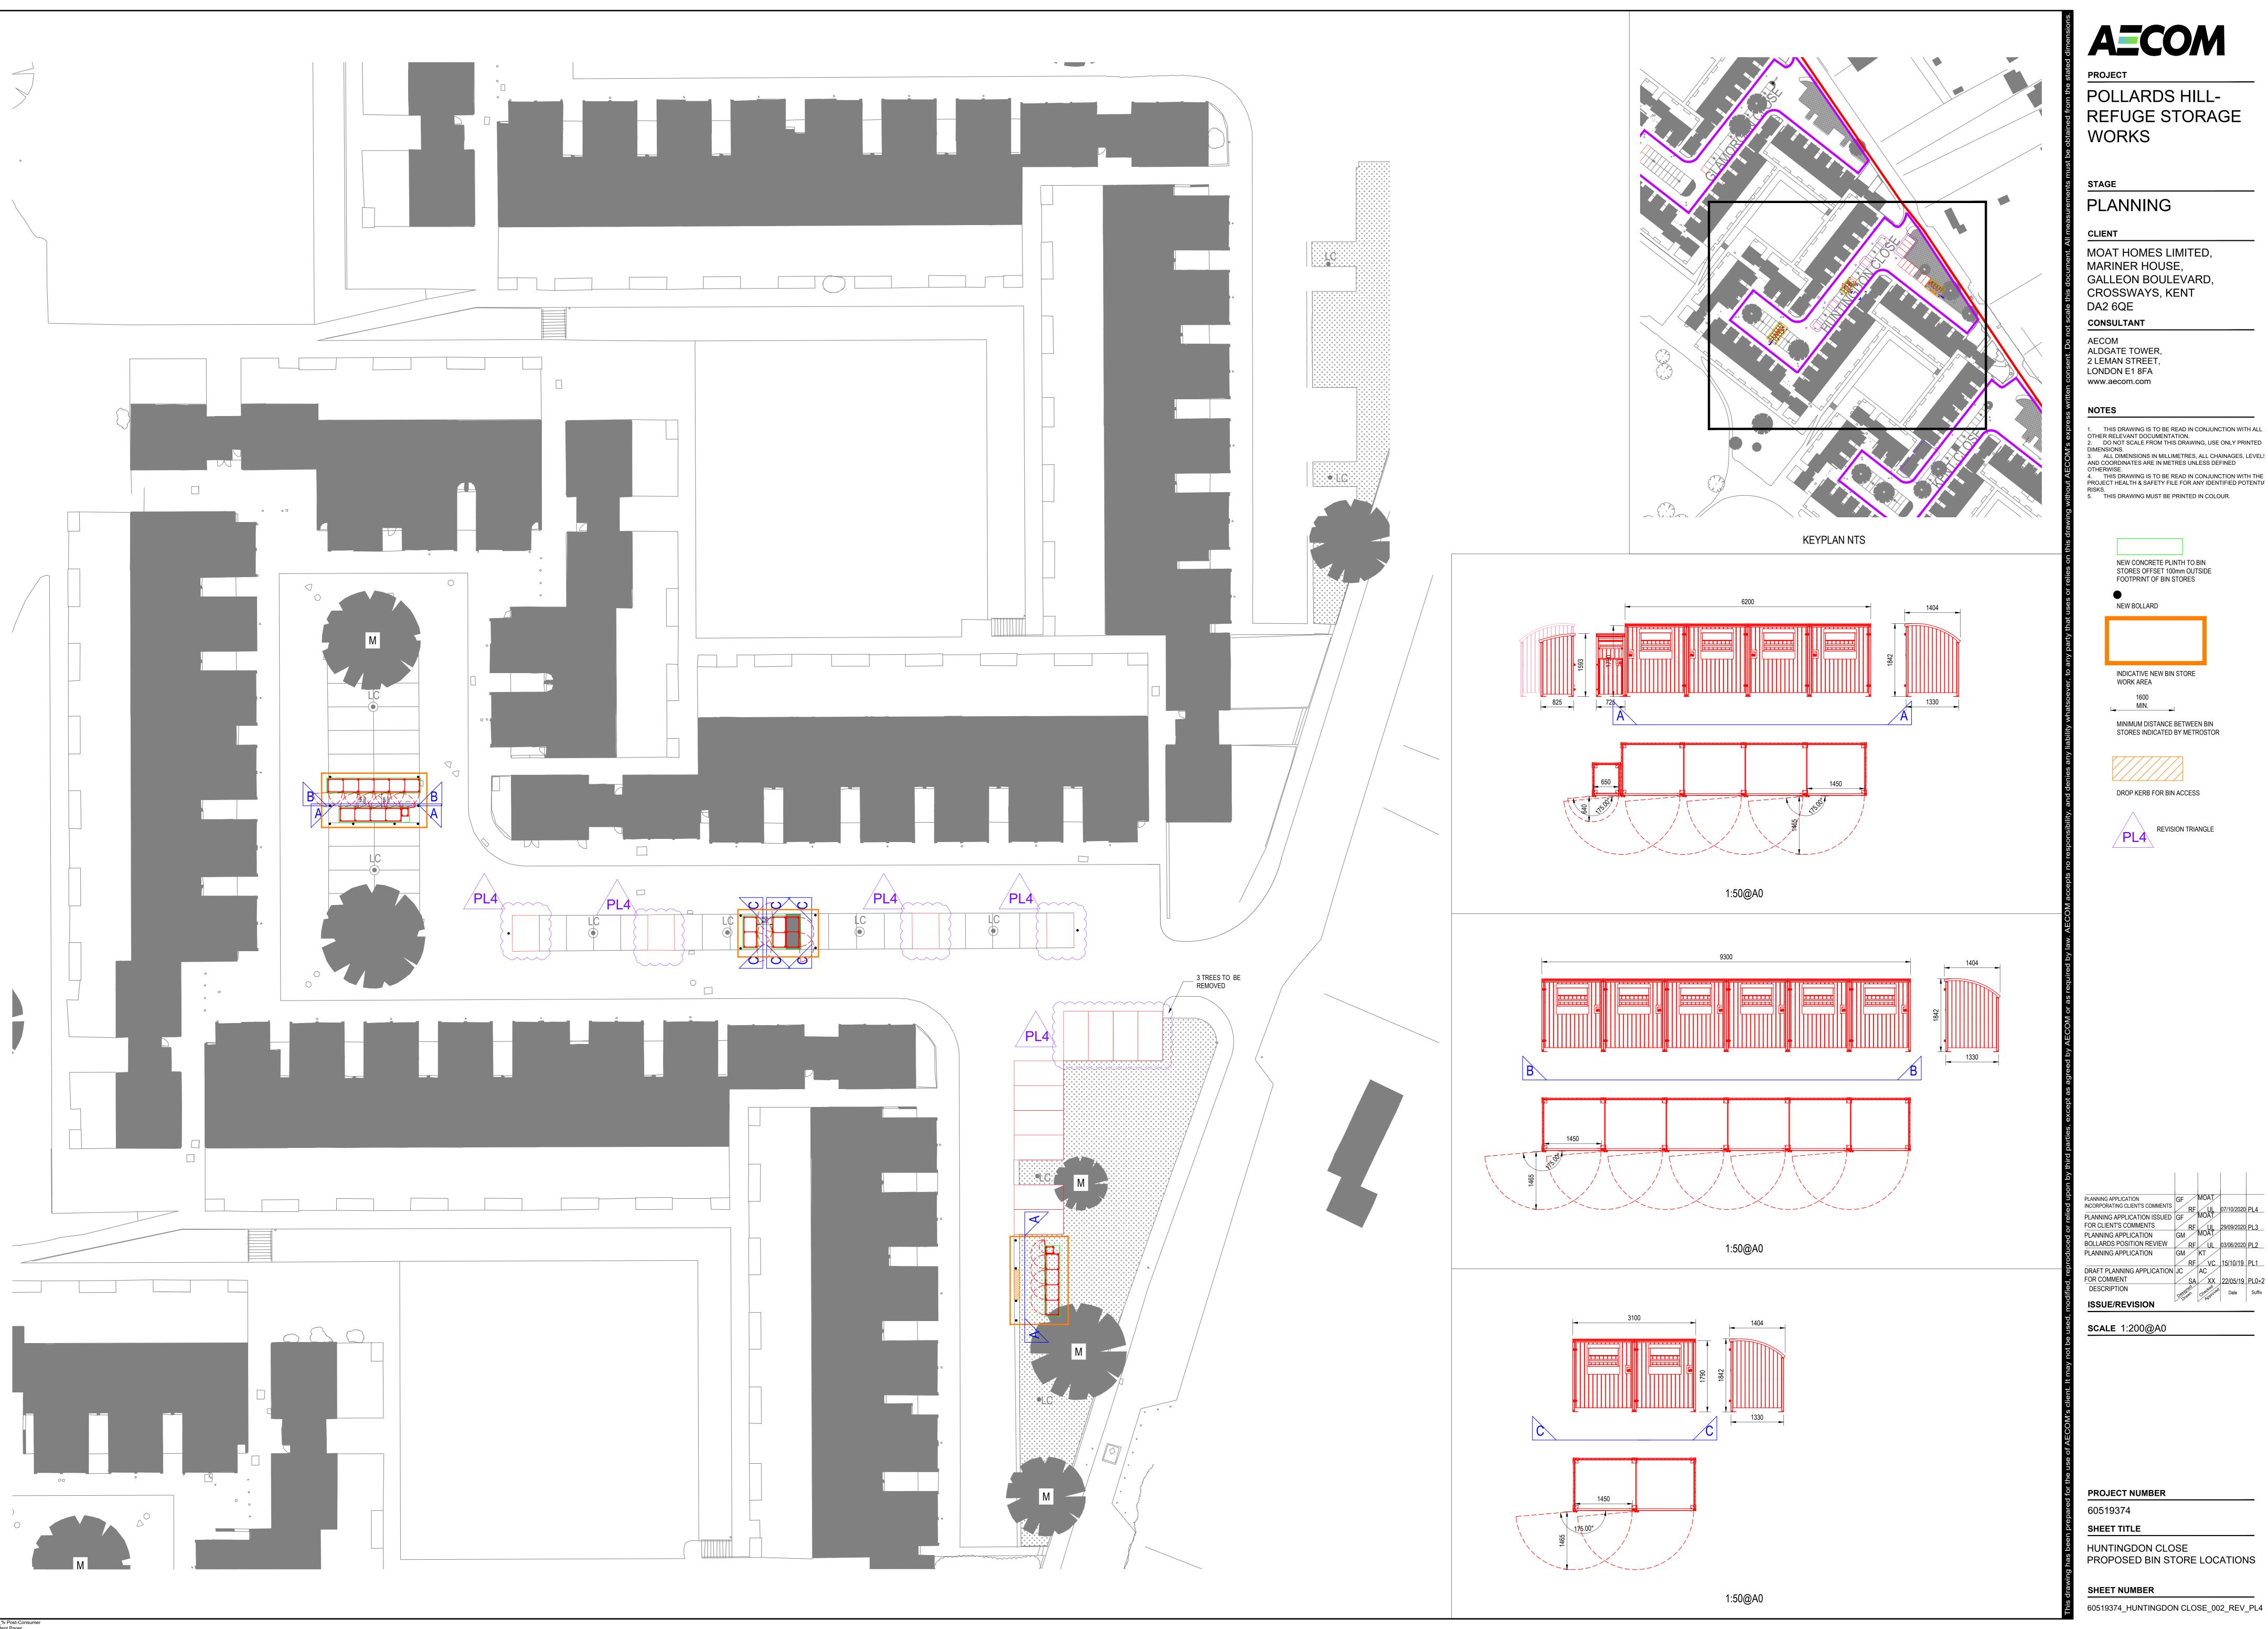

PLANNING

MOAT HOMES LIMITED, MARINER HOUSE, GALLEON BOULEVARD, CROSSWAYS, KENT DA2 6QE

ALDGATE TOWER, 2 LEMAN STREET, LONDON E1 8FA www.aecom.com

1. THIS DRAWING IS TO BE READ IN CONJUNCTION WITH ALL OTHER RELEVANT DOCUMENTATION.
2. DO NOT SCALE FROM THIS DRAWING, USE ONLY PRINTED 3. ALL DIMENSIONS IN MILLIMETRES, ALL CHAINAGES, LEVELS
AND COORDINATES ARE IN METRES UNLESS DEFINED 4. THIS DRAWING IS TO BE READ IN CONJUNCTION WITH THE

> NEW CONCRETE PLINTH TO BIN STORES OFFSET 100mm OUTSIDE FOOTPRINT OF BIN STORES

NEW BOLLARD

INDICATIVE NEW BIN STORE WORK AREA

MINIMUM DISTANCE BETWEEN BIN STORES INDICATED BY METROSTOR

PLANNING APPLICATION
INCORPORATING CLIENT'S COMMENTS BOLLARDS POSITION REVIEW RF UL 03/06/2020 PL2
PLANNING APPLICATION GM KT FOR COMMENT

ISSUE/REVISION

SCALE 1:200@A0


PROJECT NUMBER

SHEET TITLE **HUNTINGDON CLOSE**

PROPOSED BIN STORE LOCATIONS

SHEET NUMBER

60519374_HUNTINGDON CLOSE_002_REV_PL4

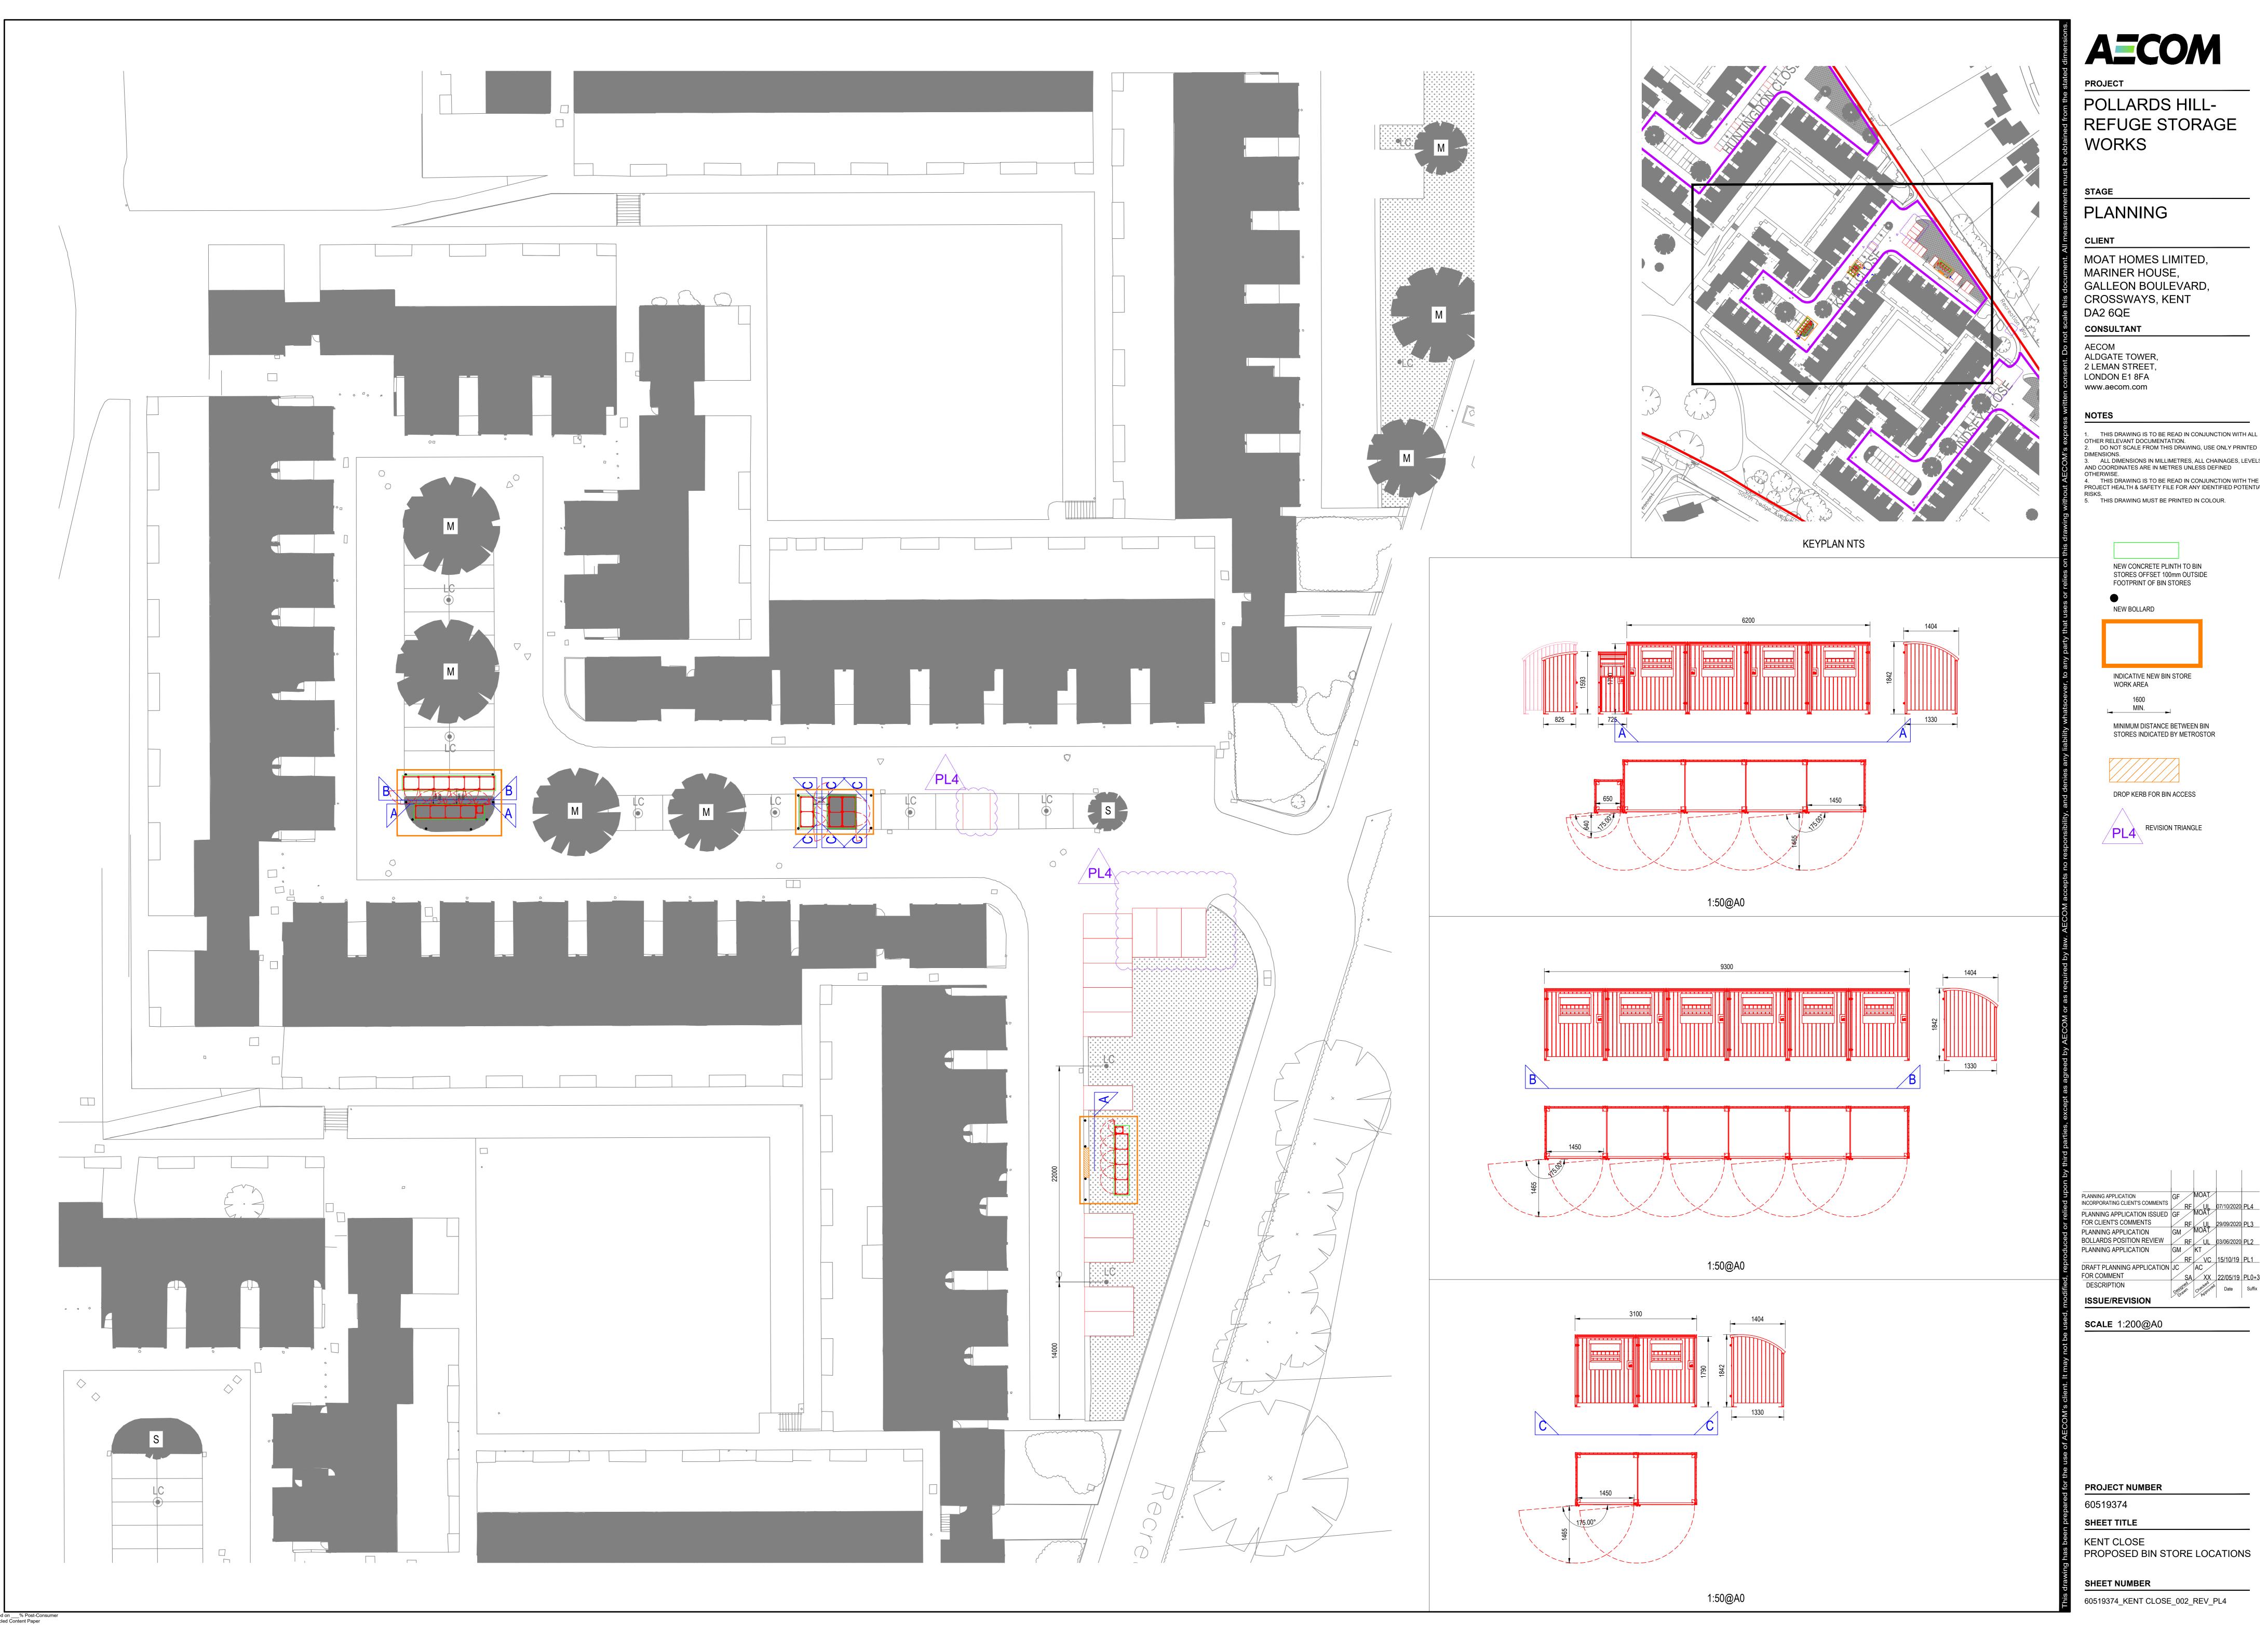

MOAT HOMES LIMITED, MARINER HOUSE, GALLEON BOULEVARD, CROSSWAYS, KENT

ALDGATE TOWER, 2 LEMAN STREET, LONDON E1 8FA

 THIS DRAWING IS TO BE READ IN CONJUNCTION WITH ALL OTHER RELEVANT DOCUMENTATION.
 DO NOT SCALE FROM THIS DRAWING, USE ONLY PRINTED 3. ALL DIMENSIONS IN MILLIMETRES, ALL CHAINAGES, LEVELS
AND COORDINATES ARE IN METRES UNLESS DEFINED

> NEW CONCRETE PLINTH TO BIN STORES OFFSET 100mm OUTSIDE FOOTPRINT OF BIN STORES

INDICATIVE NEW BIN STORE WORK AREA

PLANNING APPLICATION INCORPORATING CLIENT'S COMMENTS BOLLARDS POSITION REVIEW RF UL 03/06/2020 PL2
PLANNING APPLICATION GM KT


SCALE 1:200@A0

SHEET TITLE

KENT CLOSE

SHEET NUMBER

60519374_KENT CLOSE_002_REV_PL4

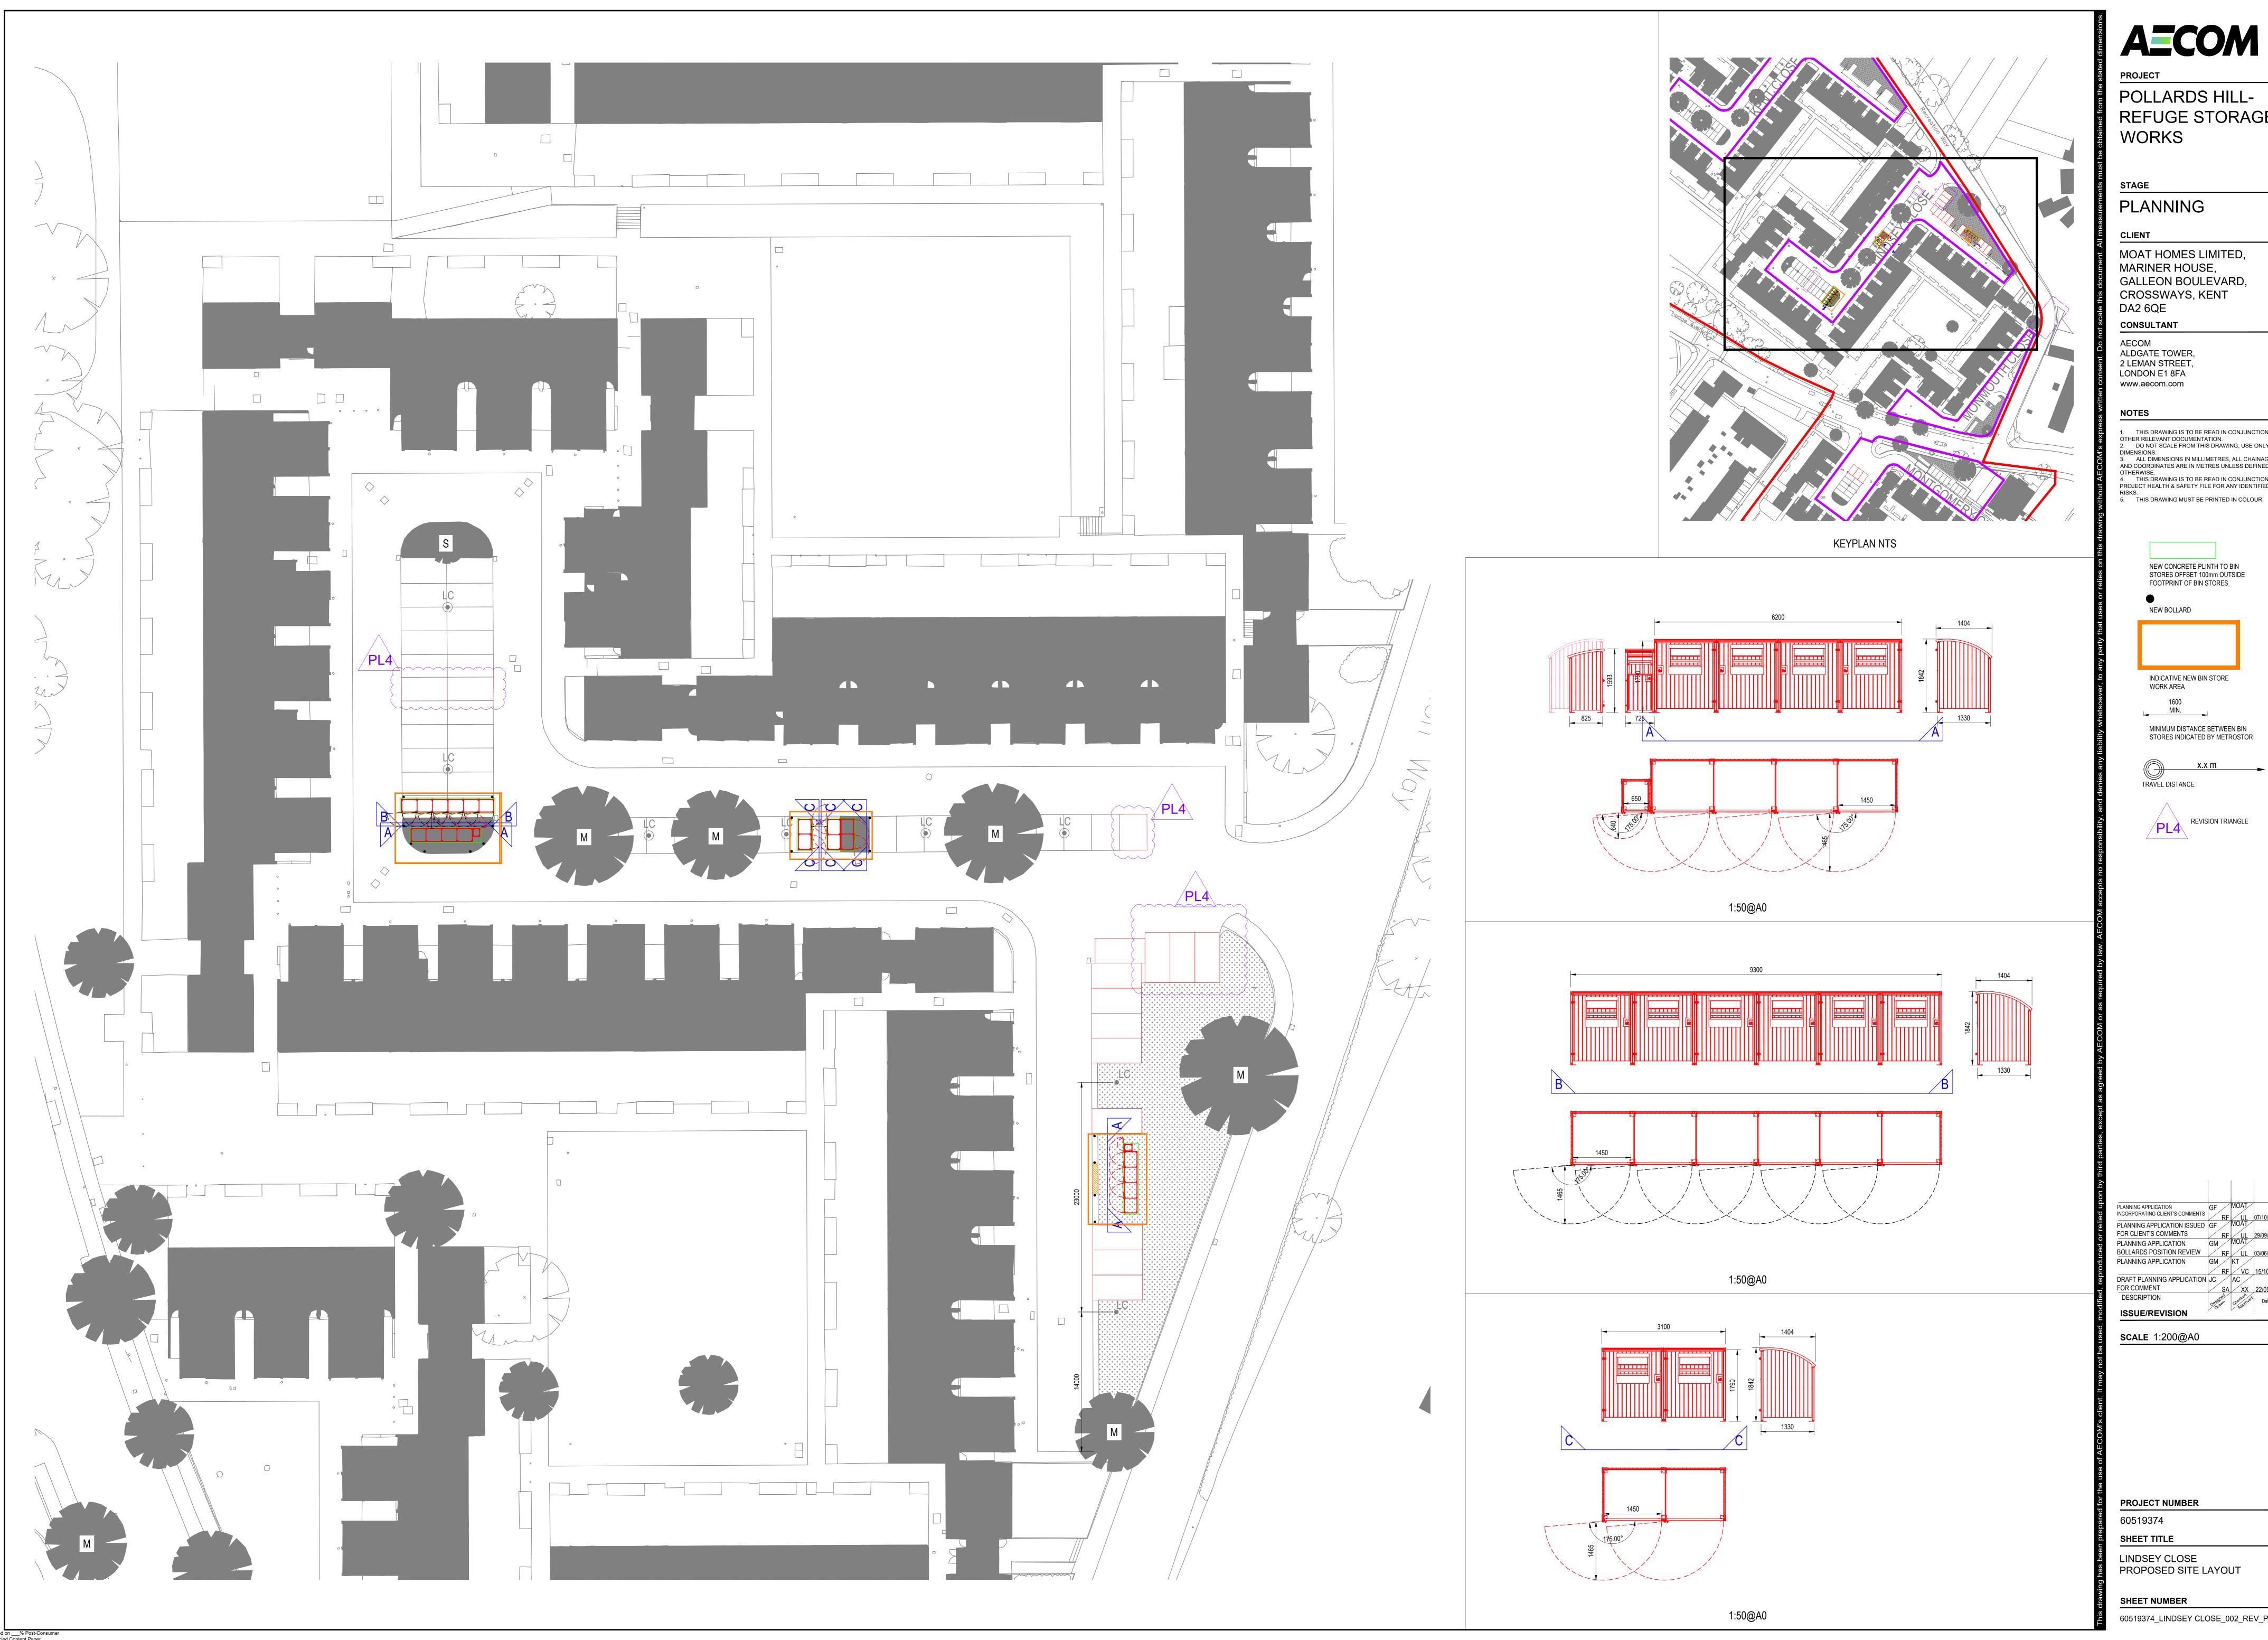

POLLARDS HILL-REFUGE STORAGE WORKS

PLANNING

MOAT HOMES LIMITED, MARINER HOUSE, GALLEON BOULEVARD, CROSSWAYS, KENT DA2 6QE

ALDGATE TOWER, 2 LEMAN STREET, LONDON E1 8FA www.aecom.com

 THIS DRAWING IS TO BE READ IN CONJUNCTION WITH ALL OTHER RELEVANT DOCUMENTATION.
 DO NOT SCALE FROM THIS DRAWING, USE ONLY PRINTED 3. ALL DIMENSIONS IN MILLIMETRES, ALL CHAINAGES, LEVELS
AND COORDINATES ARE IN METRES UNLESS DEFINED 4. THIS DRAWING IS TO BE READ IN CONJUNCTION WITH THE PROJECT HEALTH & SAFETY FILE FOR ANY IDENTIFIED POTENTIA

> NEW CONCRETE PLINTH TO BIN STORES OFFSET 100mm OUTSIDE FOOTPRINT OF BIN STORES

NEW BOLLARD

INDICATIVE NEW BIN STORE **WORK AREA**

MINIMUM DISTANCE BETWEEN BIN STORES INDICATED BY METROSTOR

PLANNING APPLICATION INCORPORATING CLIENT'S COMMENTS BOLLARDS POSITION REVIEW RF UL 03/06/2020 PL2
PLANNING APPLICATION GM KT

ISSUE/REVISION

SCALE 1:200@A0


PROJECT NUMBER

LINDSEY CLOSE


PROPOSED SITE LAYOUT

SHEET NUMBER

60519374_LINDSEY CLOSE_002_REV_PL4

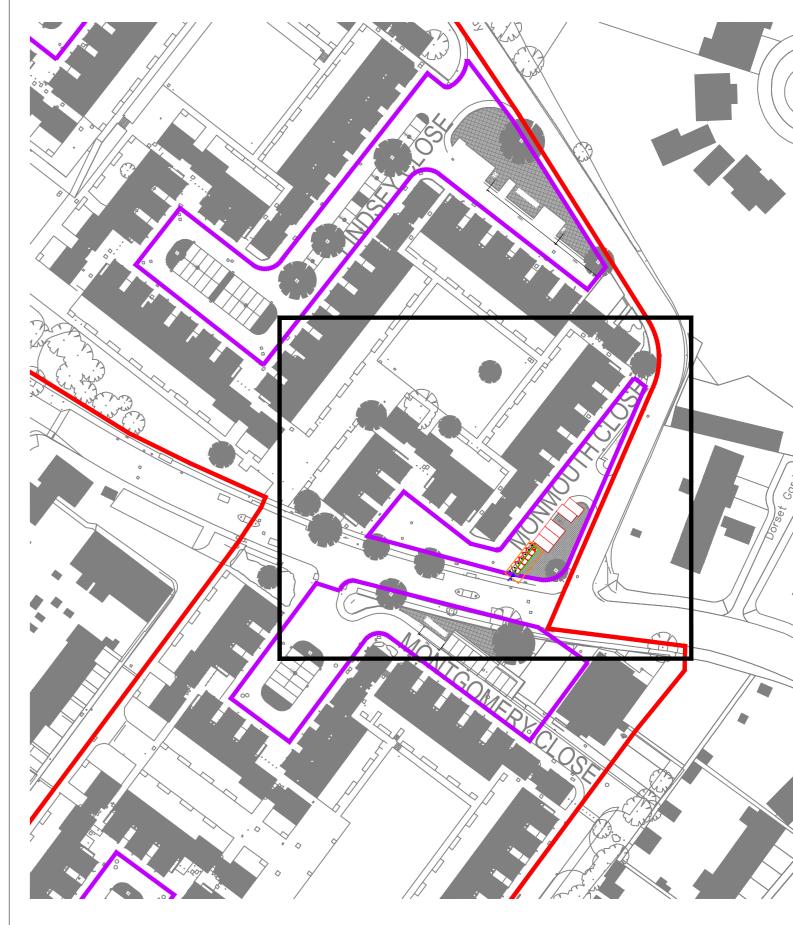

KEYPLAN NTS

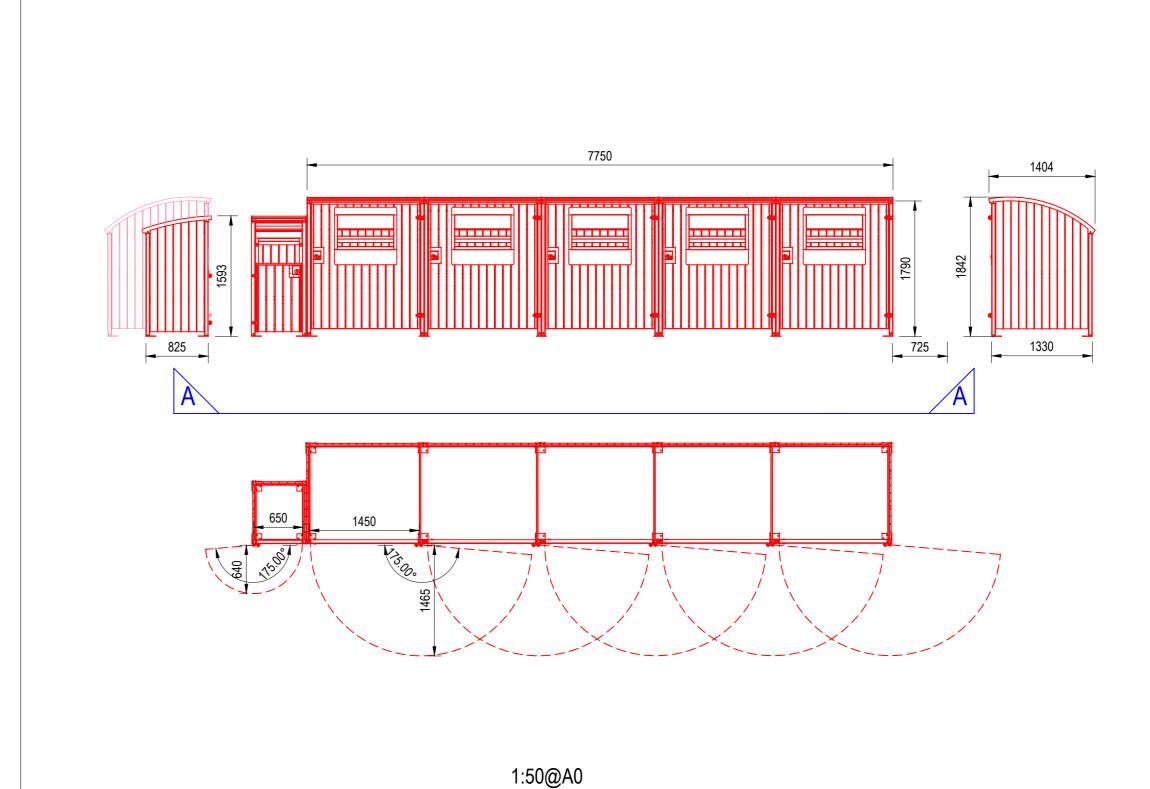

PLANNING

MOAT HOMES LIMITED, MARINER HOUSE, GALLEON BOULEVARD, CROSSWAYS, KENT DA2 6QE

AECOM ALDGATE TOWER, 2 LEMAN STREET, LONDON E1 8FA www.aecom.com

CONSULTANT

1. THIS DRAWING IS TO BE READ IN CONJUNCTION WITH ALL OTHER RELEVANT DOCUMENTATION.
2. DO NOT SCALE FROM THIS DRAWING, USE ONLY PRINTED 3. ALL DIMENSIONS IN MILLIMETRES, ALL CHAINAGES, LEVELS
AND COORDINATES ARE IN METRES UNLESS DEFINED 4. THIS DRAWING IS TO BE READ IN CONJUNCTION WITH THE PROJECT HEALTH & SAFETY FILE FOR ANY IDENTIFIED POTENTIF

5. THIS DRAWING MUST BE PRINTED IN COLOUR.

NEW CONCRETE PLINTH TO BIN STORES OFFSET 100mm OUTSIDE

FOOTPRINT OF BIN STORES

INDICATIVE NEW BIN STORE WORK AREA

STORES INDICATED BY METROSTOR

PLANNING APPLICATION GM KT FOR COMMENT

ISSUE/REVISION

SCALE 1:200@A0

PROJECT NUMBER

SHEET TITLE

MONMOUTH CLOSE PROPOSED BIN STORE LOCATIONS

SHEET NUMBER

60519374_MONMOUTH CLOSE_002_REV_PL1

POLLARDS HILL-REFUGE STORAGE WORKS

PLANNING

MOAT HOMES LIMITED, MARINER HOUSE, GALLEON BOULEVARD, CROSSWAYS, KENT DA2 6QE

ALDGATE TOWER, 2 LEMAN STREET, LONDON E1 8FA www.aecom.com

 THIS DRAWING IS TO BE READ IN CONJUNCTION WITH ALL OTHER RELEVANT DOCUMENTATION.
 DO NOT SCALE FROM THIS DRAWING, USE ONLY PRINTED 3. ALL DIMENSIONS IN MILLIMETRES, ALL CHAINAGES, LEVELS
AND COORDINATES ARE IN METRES UNLESS DEFINED 4. THIS DRAWING IS TO BE READ IN CONJUNCTION WITH THE PROJECT HEALTH & SAFETY FILE FOR ANY IDENTIFIED POTENTIF

> NEW CONCRETE PLINTH TO BIN STORES OFFSET 100mm OUTSIDE FOOTPRINT OF BIN STORES

NEW BOLLARD

INDICATIVE NEW BIN STORE WORK AREA

MINIMUM DISTANCE BETWEEN BIN STORES INDICATED BY METROSTOR

DROP KERB FOR BIN ACCESS

PLANNING APPLICATION
INCORPORATING CLIENT'S COMMENTS BOLLARDS POSITION REVIEW RF UL 03/06/2020 PL2
PLANNING APPLICATION GM KT

ISSUE/REVISION

SCALE 1:200@A0


PROJECT NUMBER

SHEET TITLE

MONTGOMERY CLOSE PROPOSED BIN STORE LOCATIONS

SHEET NUMBER

60519374_MONTGOMERY CLOSE_002_REV_PL3

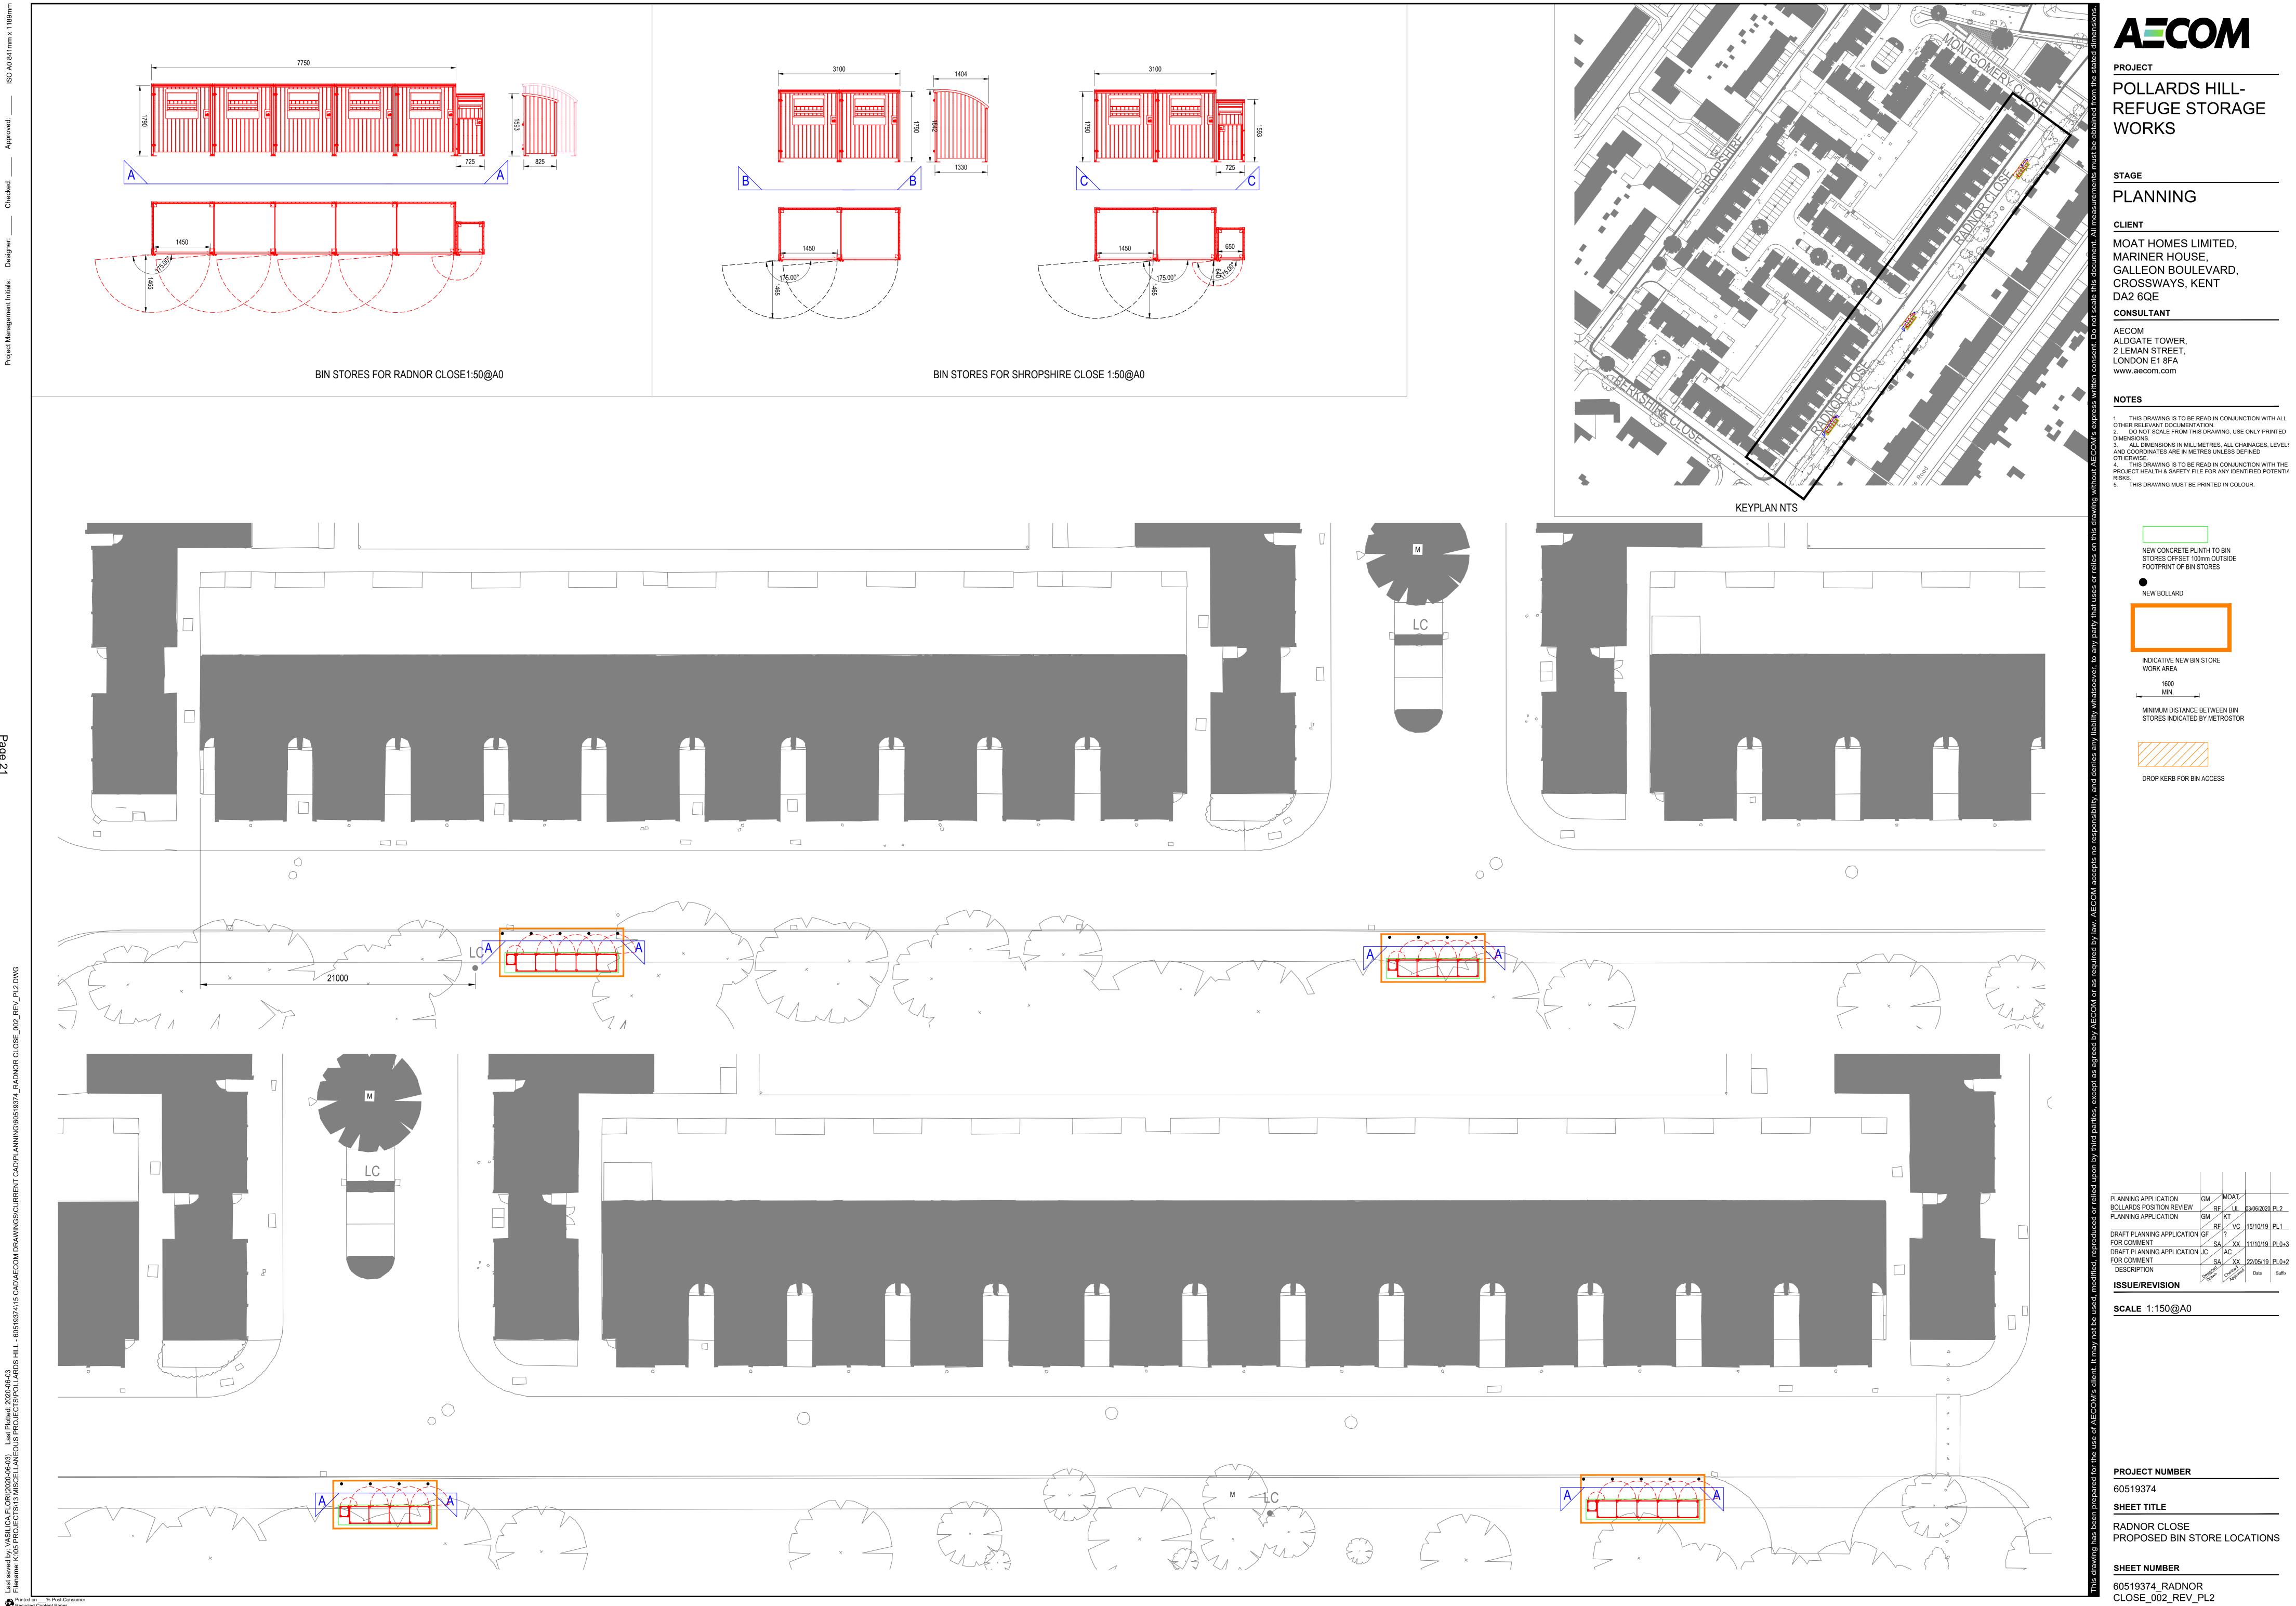

MOAT HOMES LIMITED, MARINER HOUSE, GALLEON BOULEVARD, CROSSWAYS, KENT

1. THIS DRAWING IS TO BE READ IN CONJUNCTION WITH ALL OTHER RELEVANT DOCUMENTATION.
2. DO NOT SCALE FROM THIS DRAWING, USE ONLY PRINTED 3. ALL DIMENSIONS IN MILLIMETRES, ALL CHAINAGES, LEVELS AND COORDINATES ARE IN METRES UNLESS DEFINED


NEW CONCRETE PLINTH TO BIN STORES OFFSET 100mm OUTSIDE

FOOTPRINT OF BIN STORES

INDICATIVE NEW BIN STORE

SCALE 1:150@A0

RADNOR CLOSE

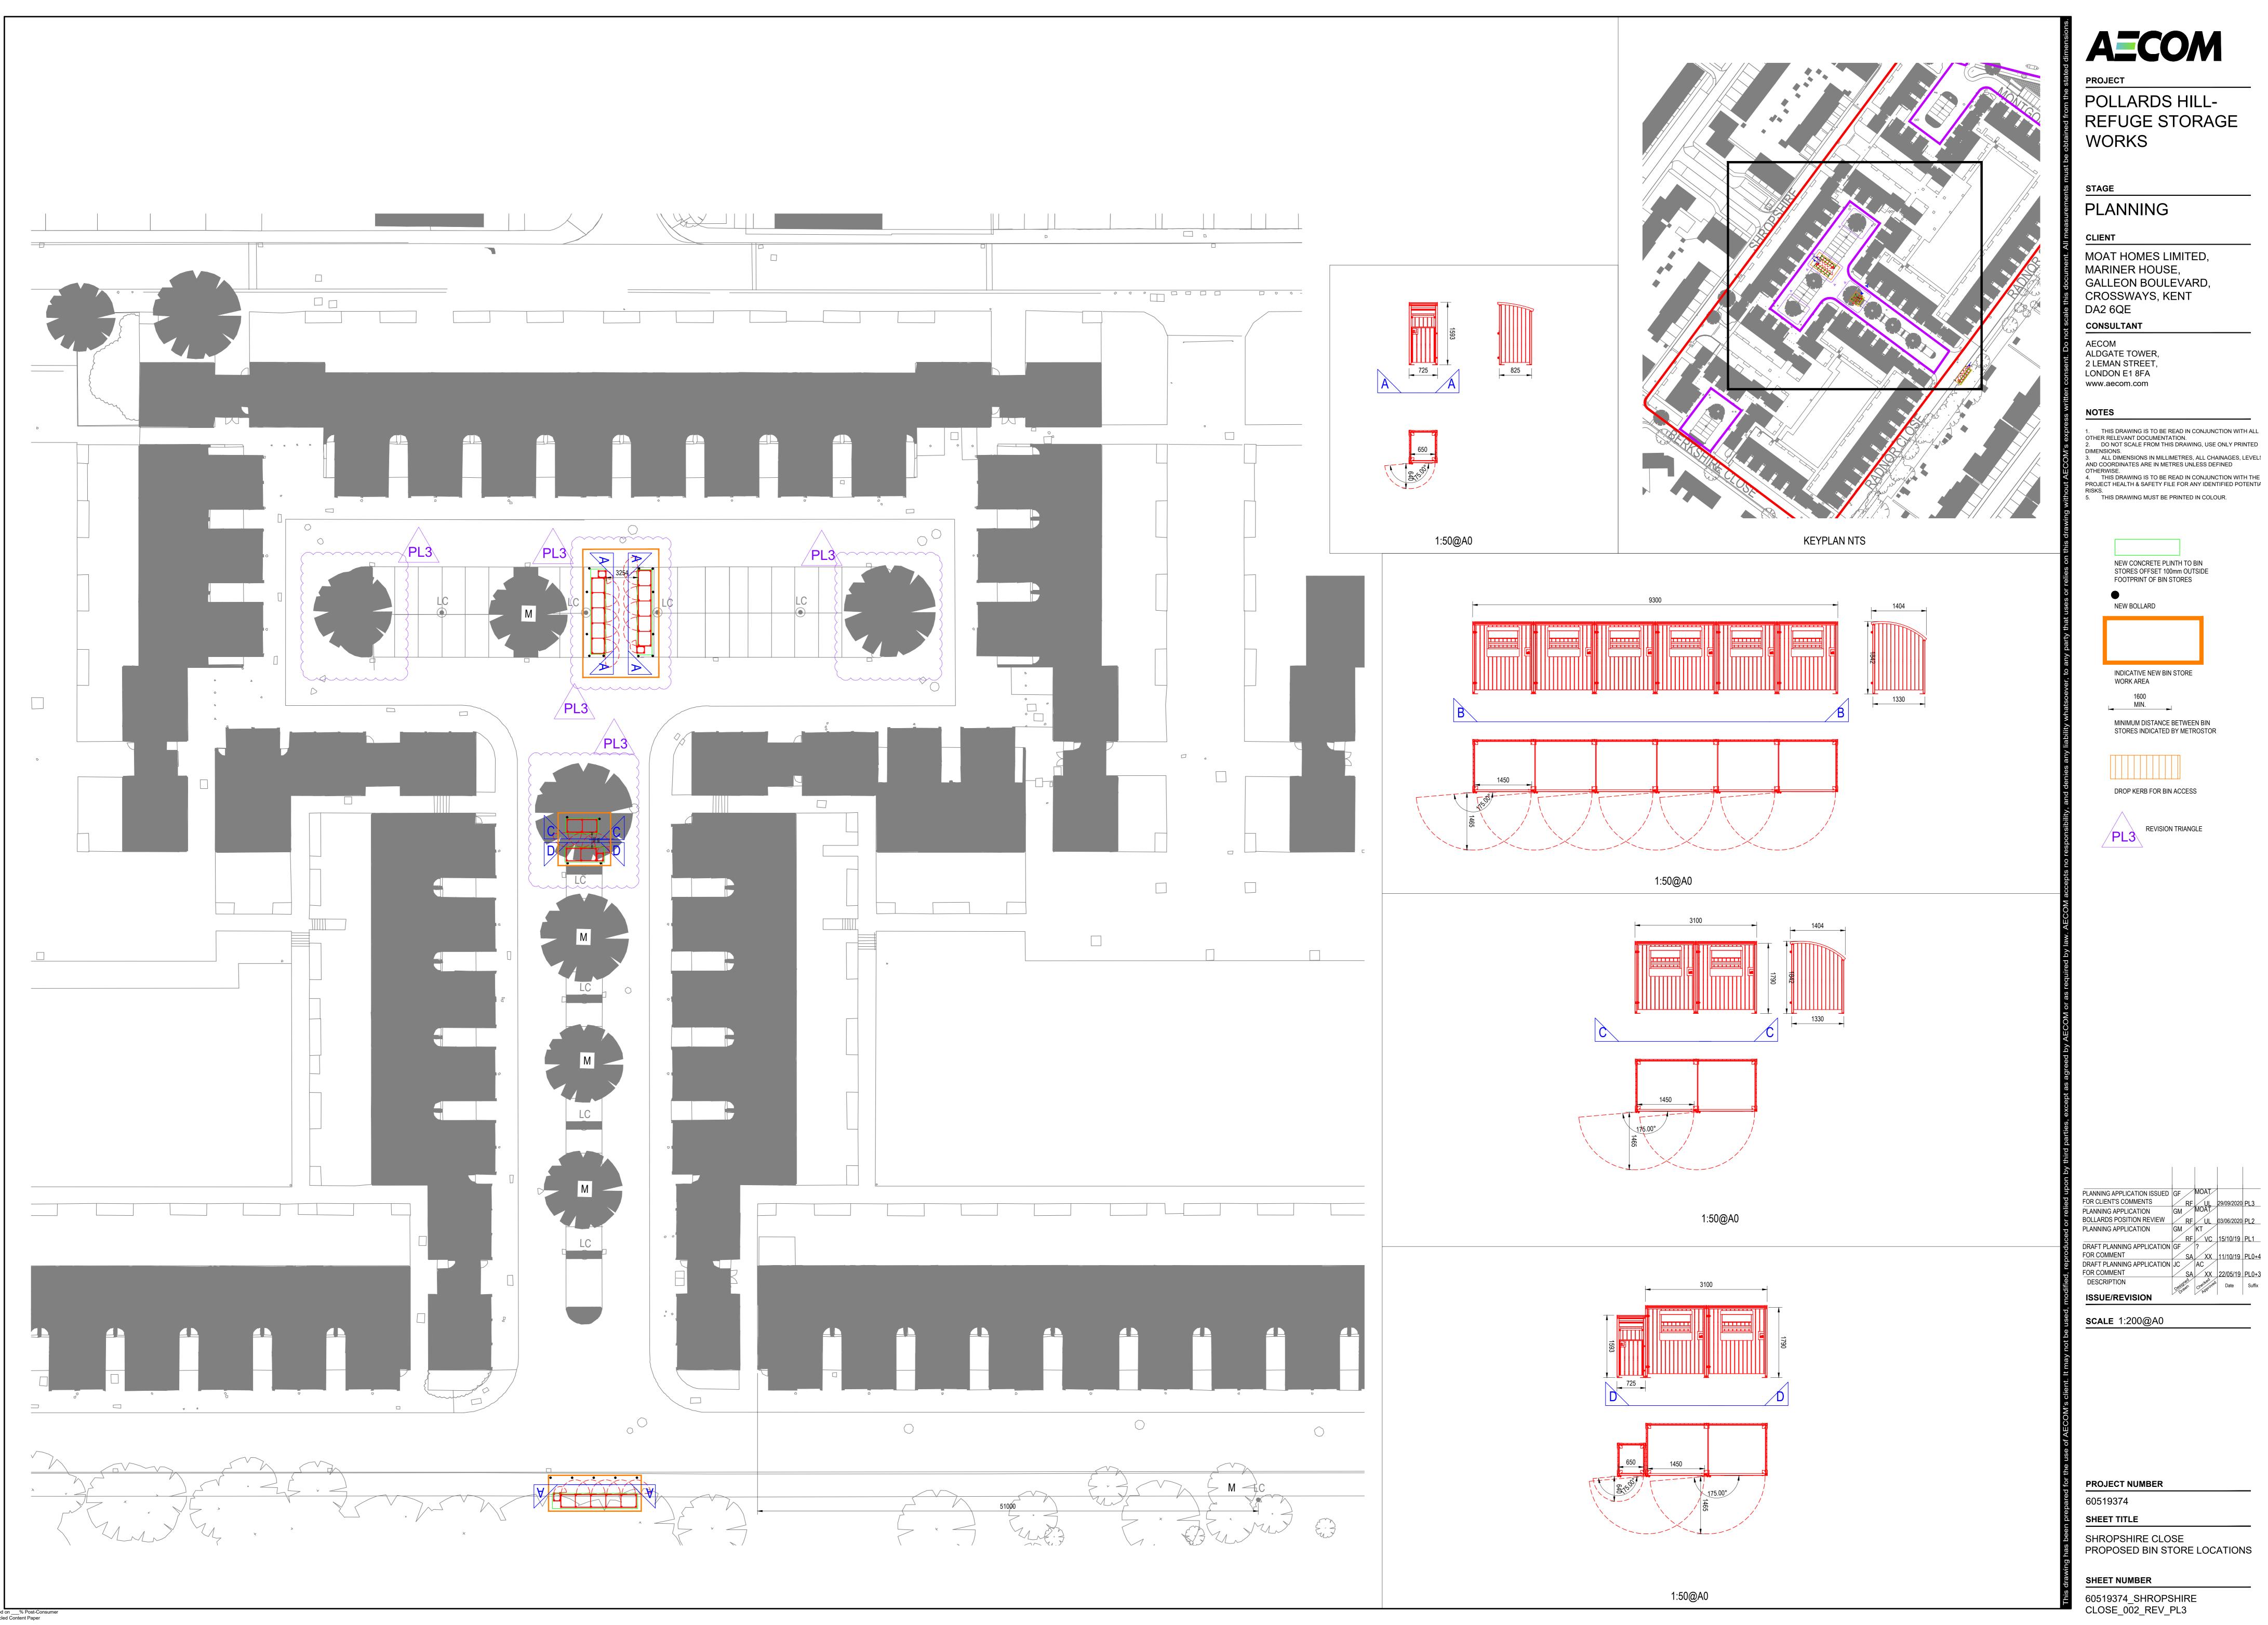

PLANNING

MOAT HOMES LIMITED, MARINER HOUSE, GALLEON BOULEVARD, CROSSWAYS, KENT

ALDGATE TOWER, 2 LEMAN STREET, LONDON E1 8FA

1. THIS DRAWING IS TO BE READ IN CONJUNCTION WITH ALL OTHER RELEVANT DOCUMENTATION.
2. DO NOT SCALE FROM THIS DRAWING, USE ONLY PRINTED 3. ALL DIMENSIONS IN MILLIMETRES, ALL CHAINAGES, LEVELS
AND COORDINATES ARE IN METRES UNLESS DEFINED

> NEW CONCRETE PLINTH TO BIN STORES OFFSET 100mm OUTSIDE FOOTPRINT OF BIN STORES

INDICATIVE NEW BIN STORE WORK AREA

MINIMUM DISTANCE BETWEEN BIN STORES INDICATED BY METROSTOR

DROP KERB FOR BIN ACCESS

PLANNING APPLICATION ISSUED GF FOR CLIENT'S COMMENTS

ISSUE/REVISION


SCALE 1:200@A0


60519374 SHEET TITLE

SHROPSHIRE CLOSE PROPOSED BIN STORE LOCATIONS

SHEET NUMBER

60519374_SHROPSHIRE CLOSE_002_REV_PL3

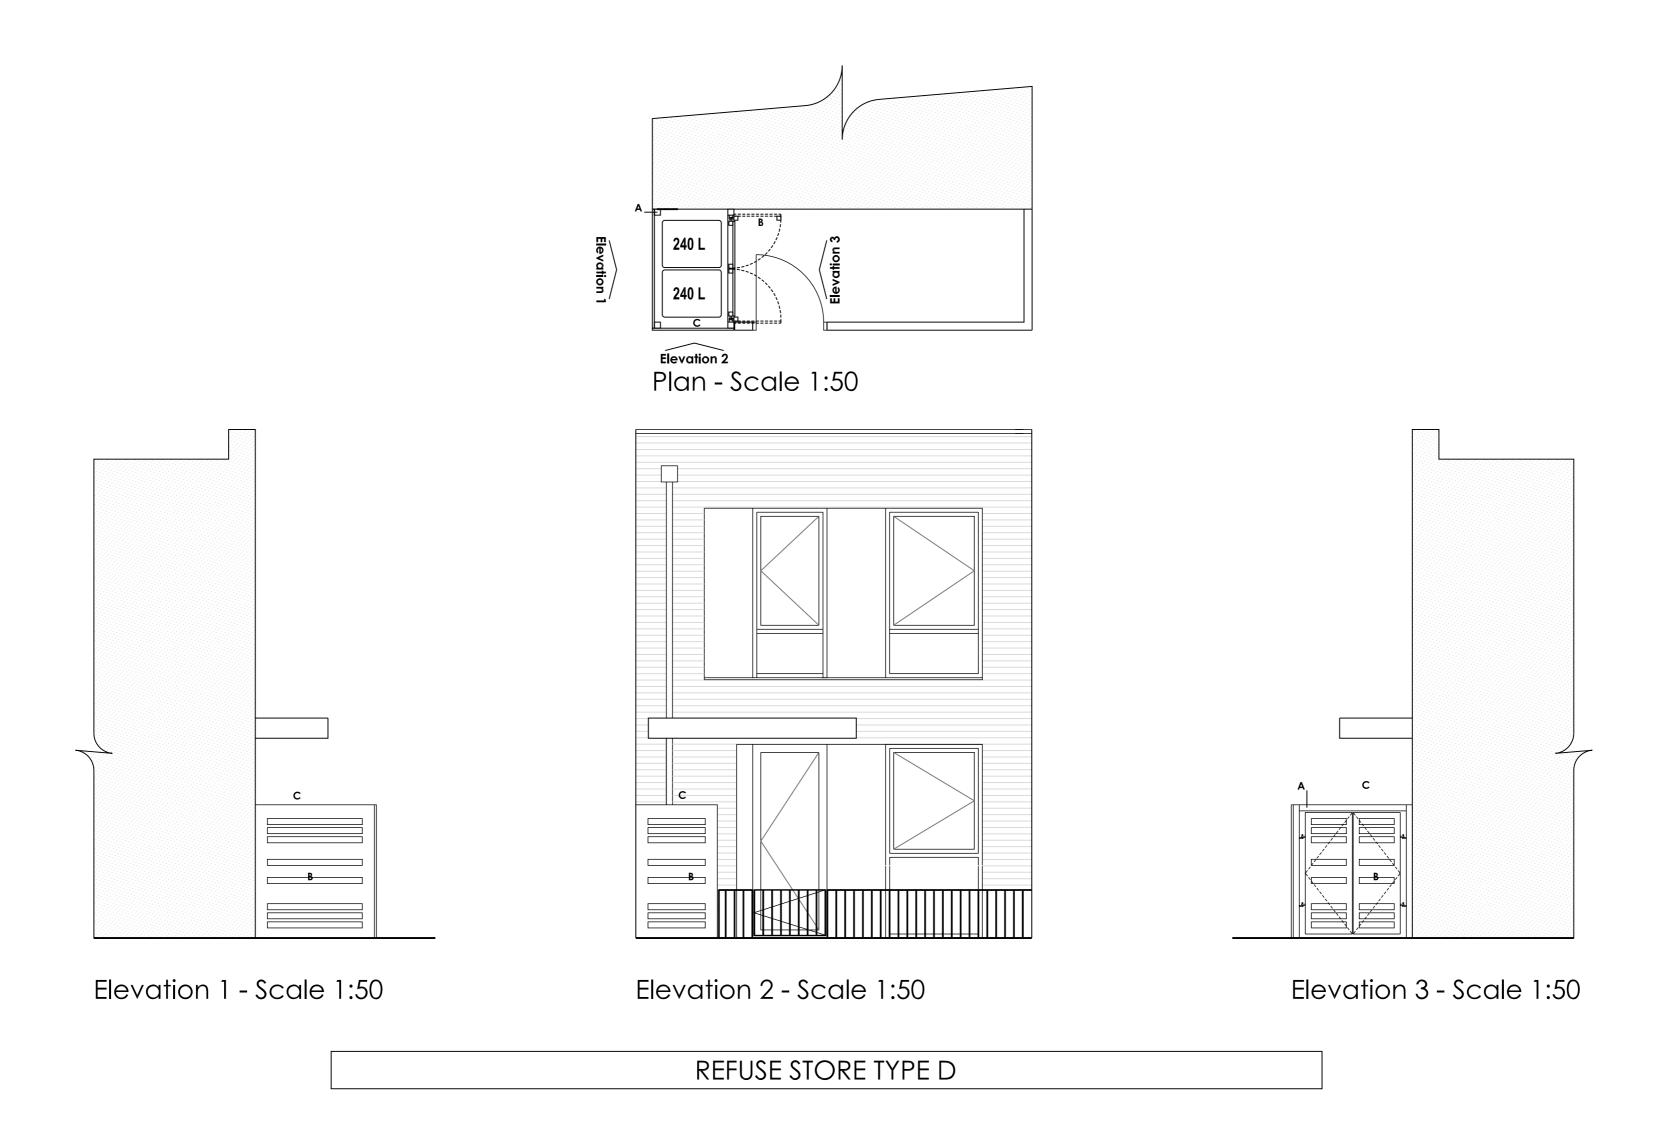

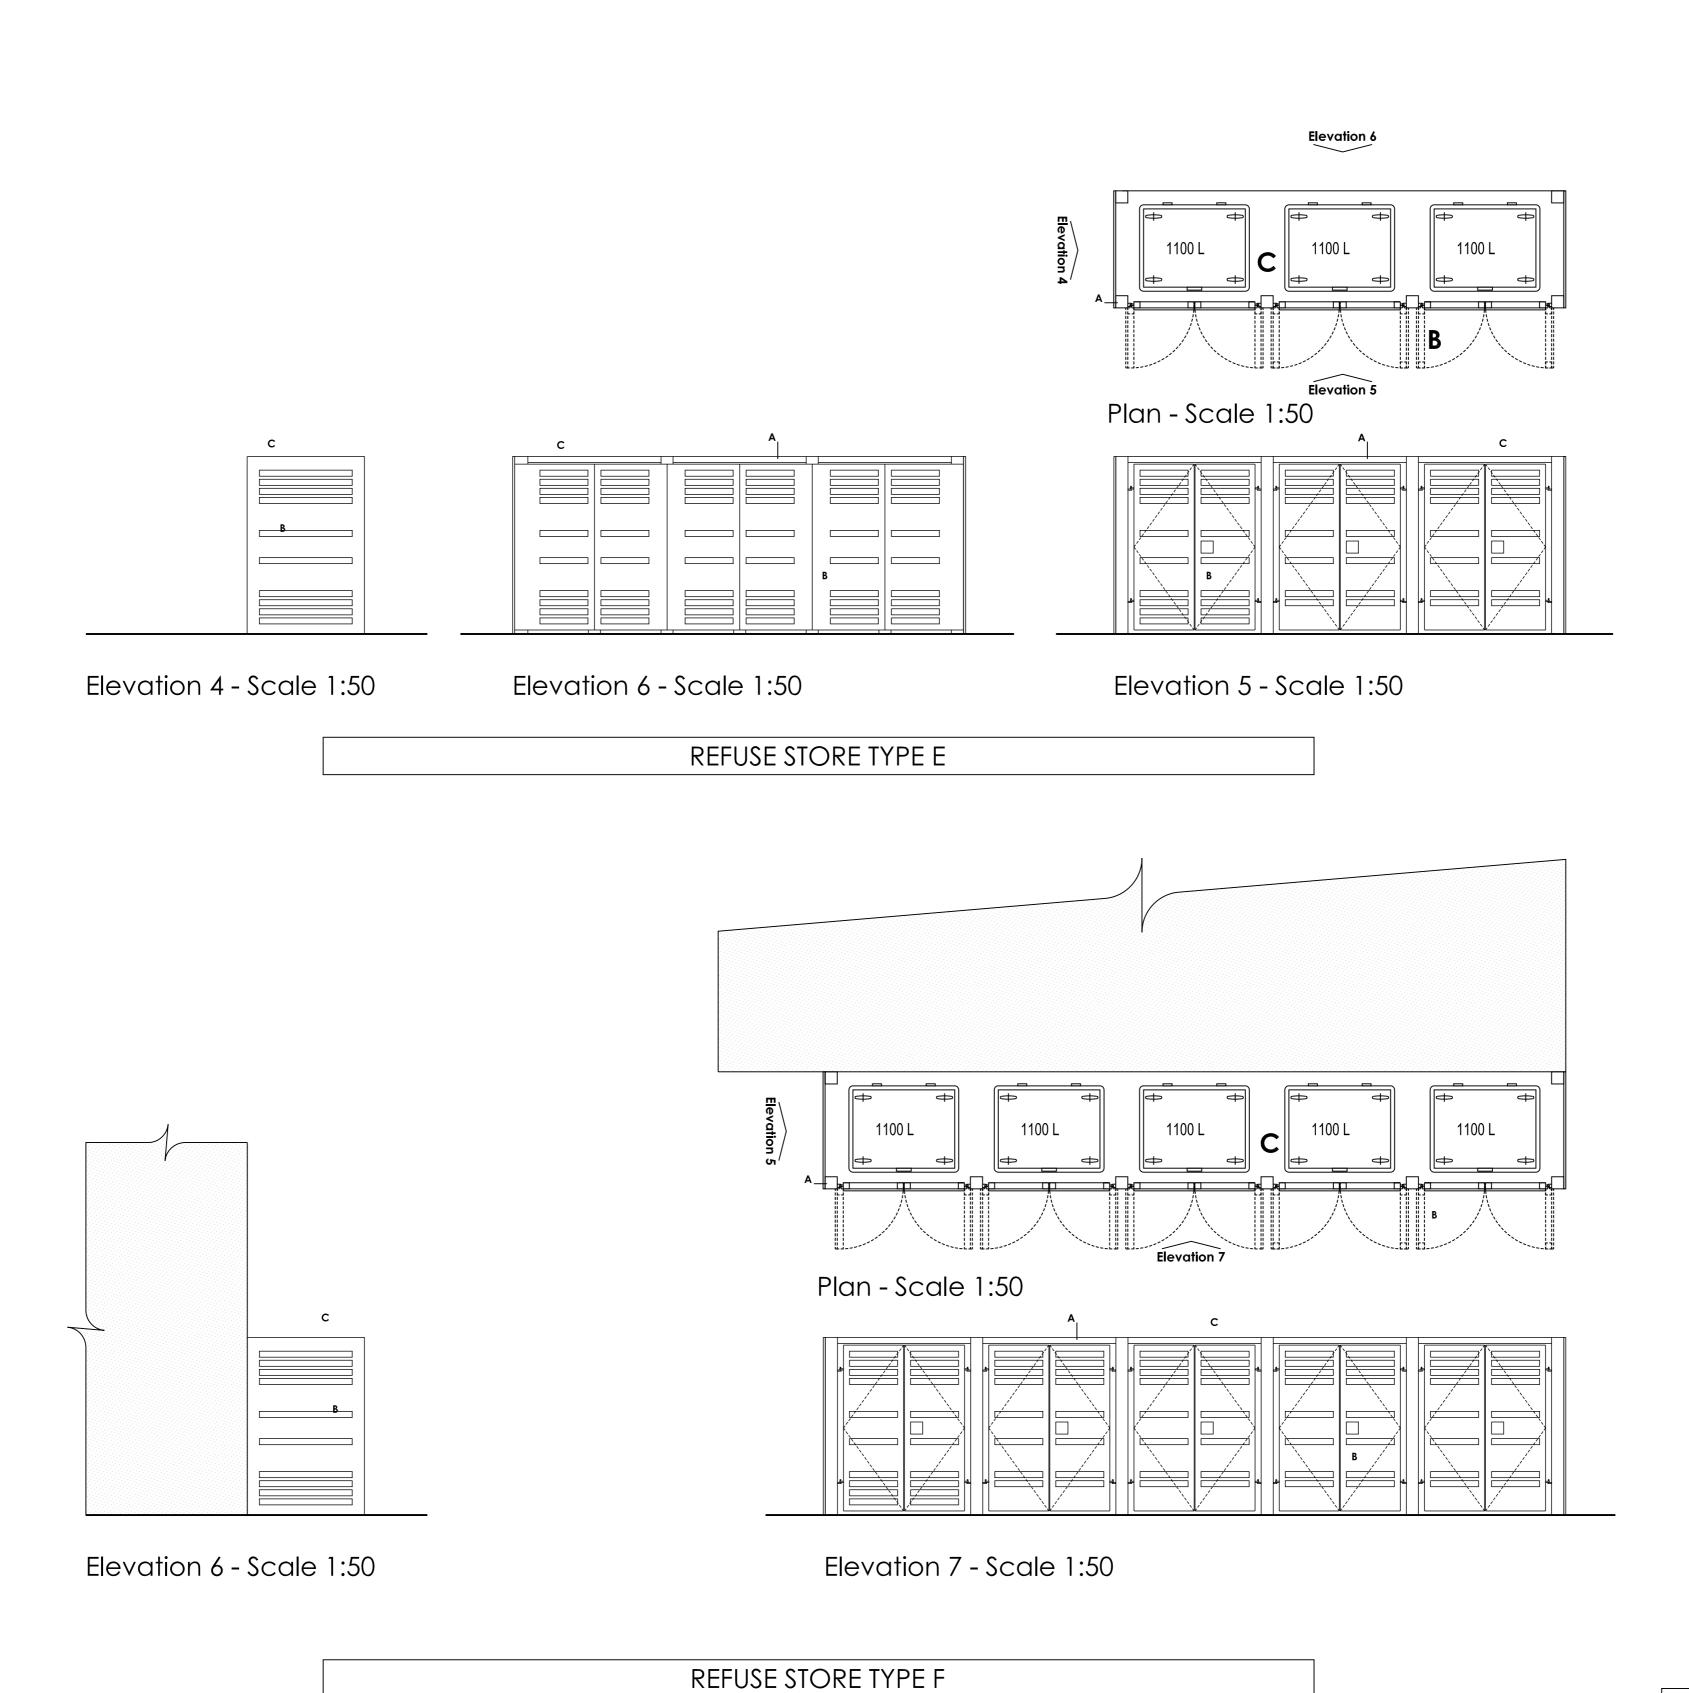


A. Treated softwood Frame.

B. Marine plywood clad doors or screens.

C. Enclosure open to sky.

D. Existing RC slab removed to allow level threshold.

Construction Notes:

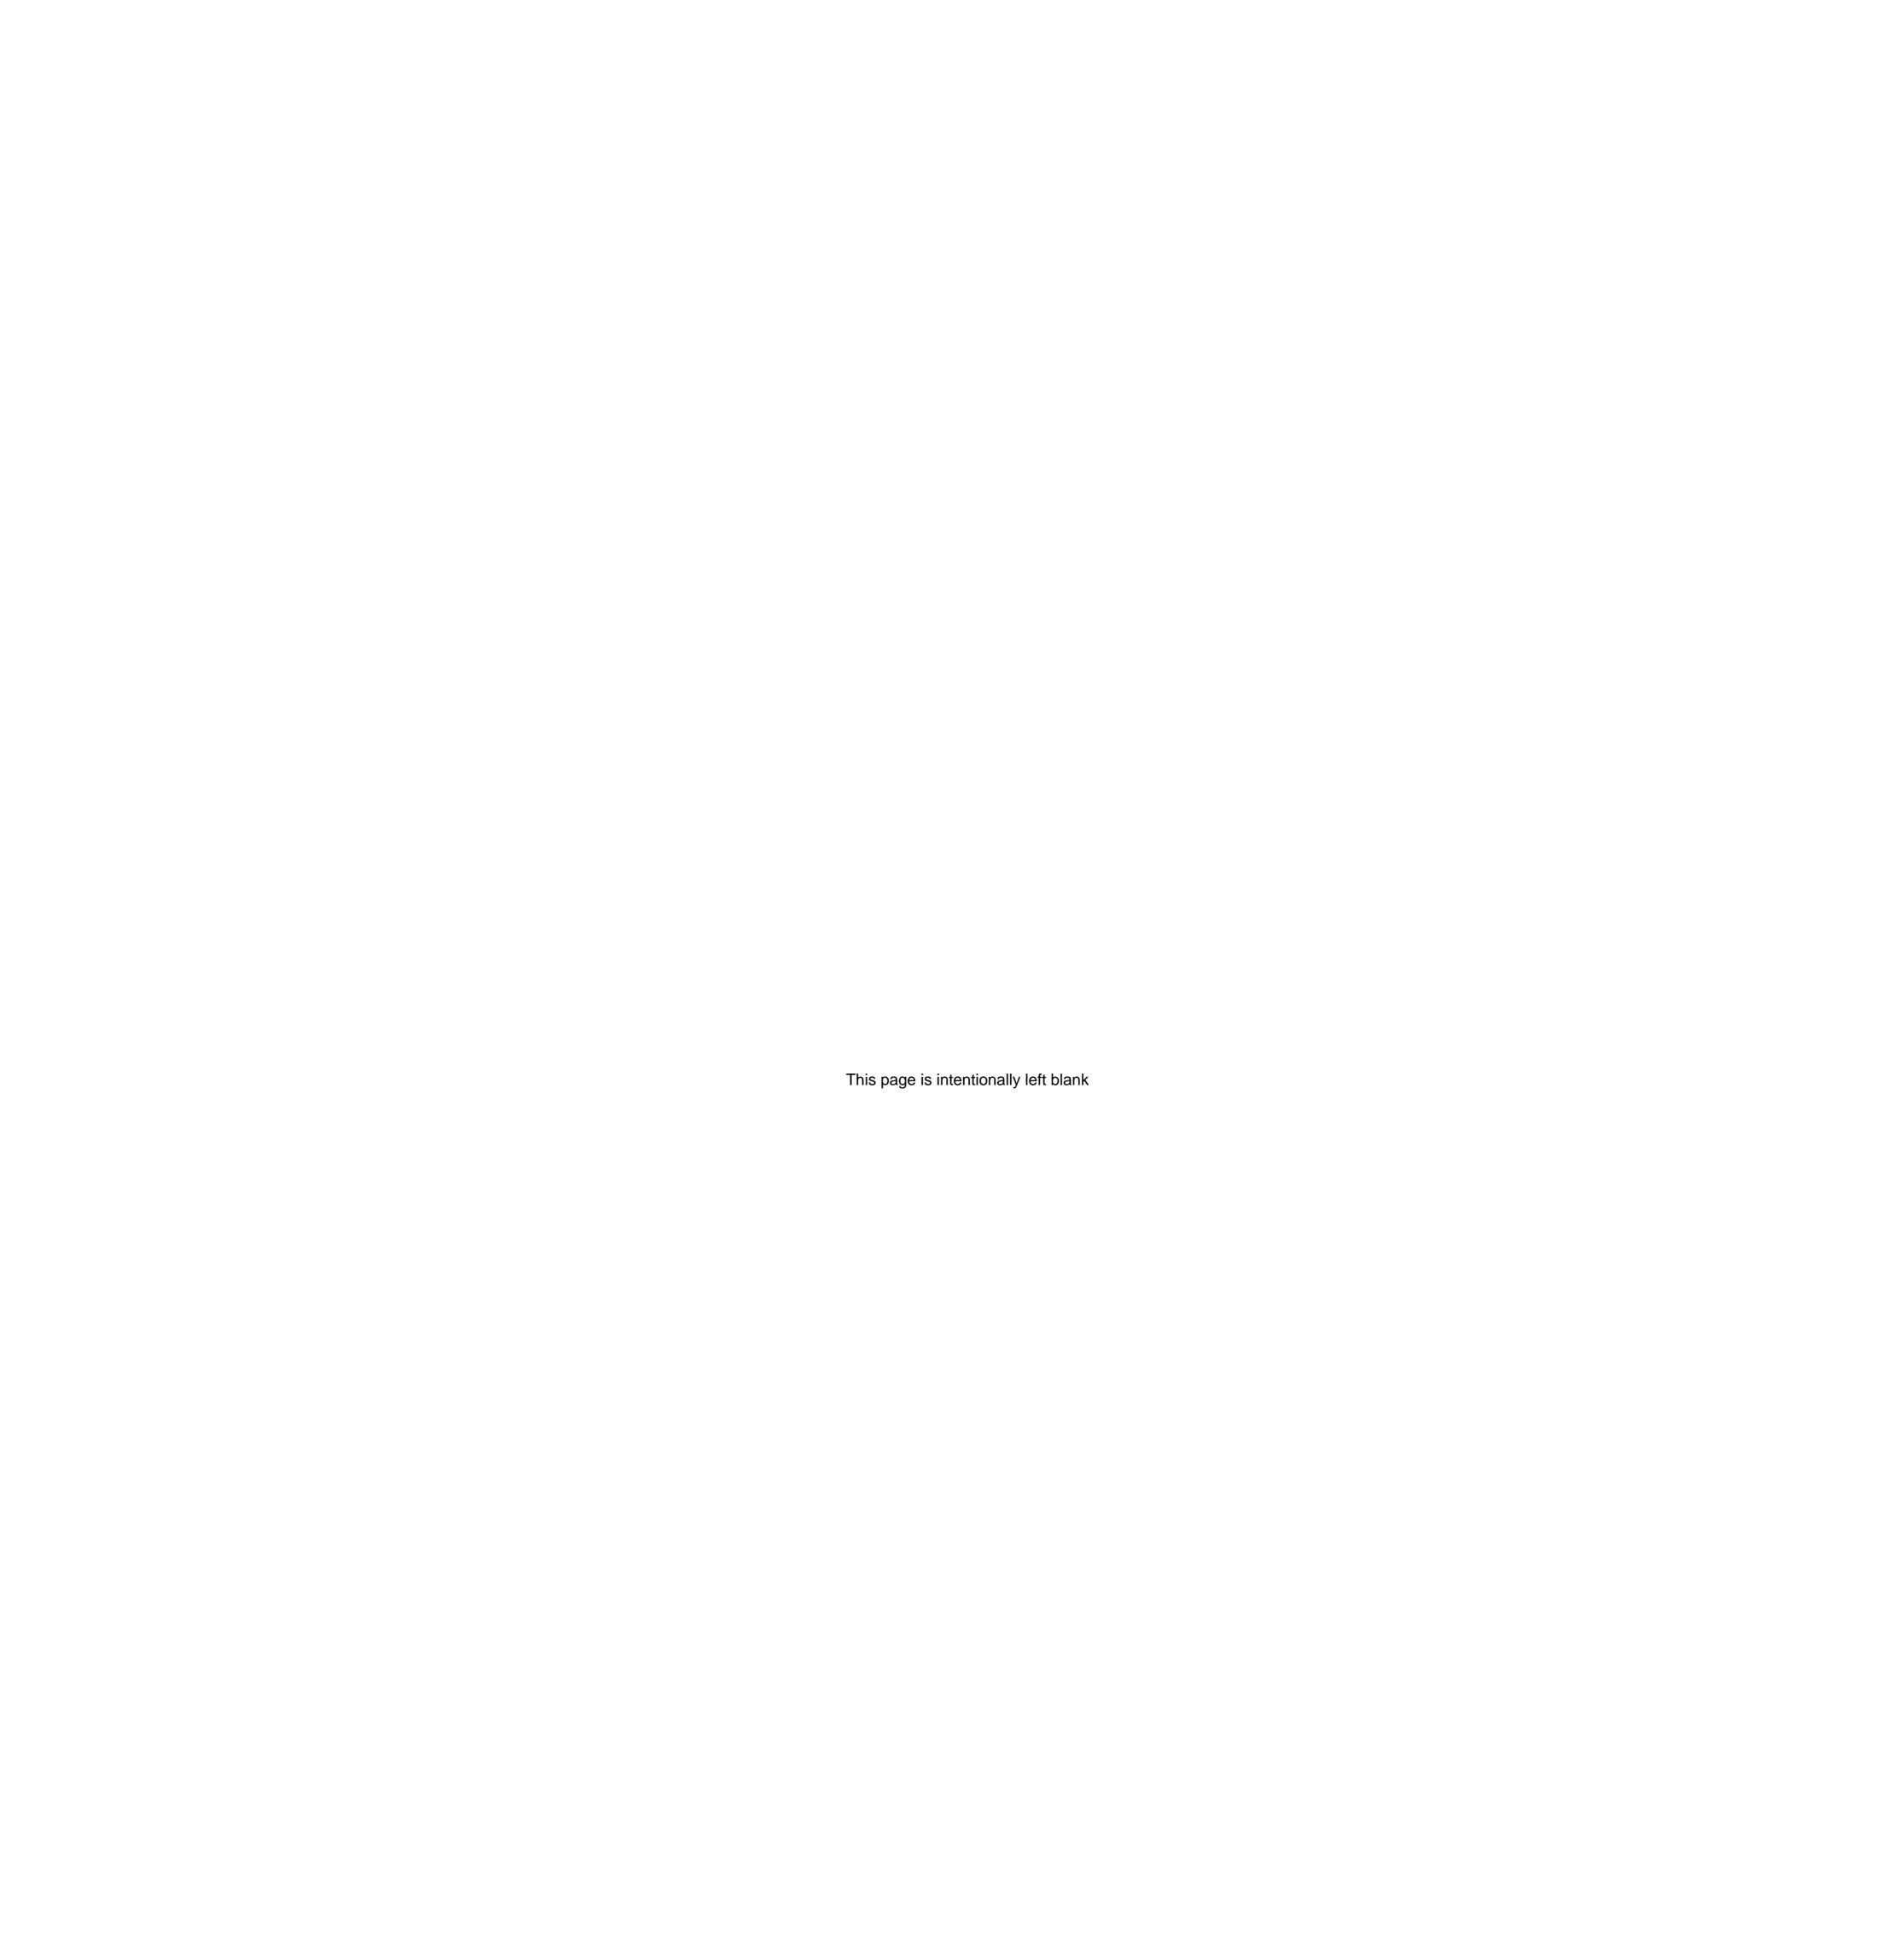

nMoathomes

Date: 21 February 2019

Quotation Ref: 15028

Project Contact : Alan Mortimer






nMoathomes

Date: 21 February 2019

Quotation Ref: 15028


Project Contact : Alan Mortimer

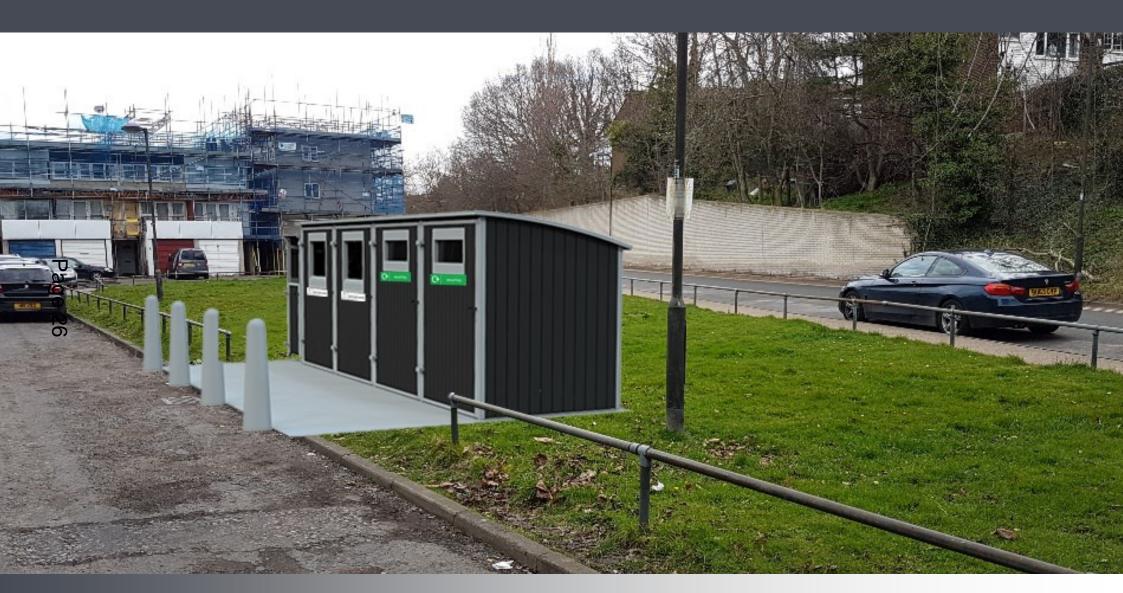






This page is intentionally left blank

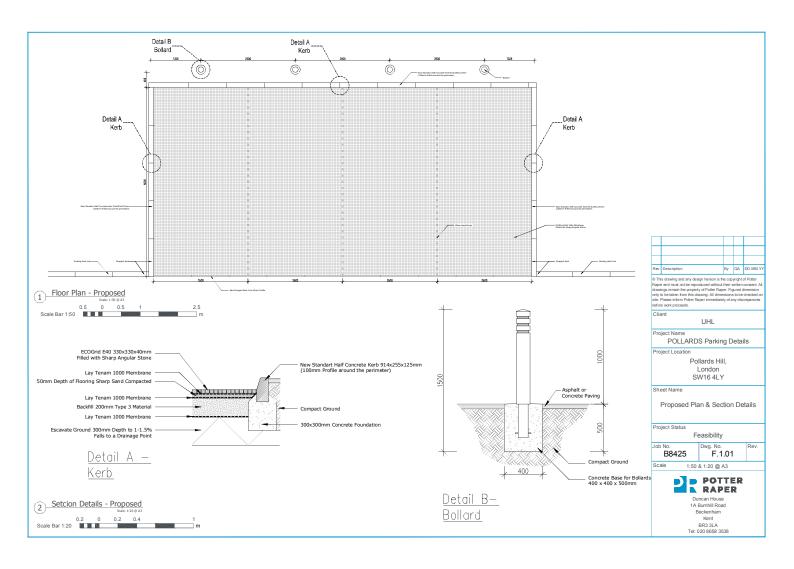




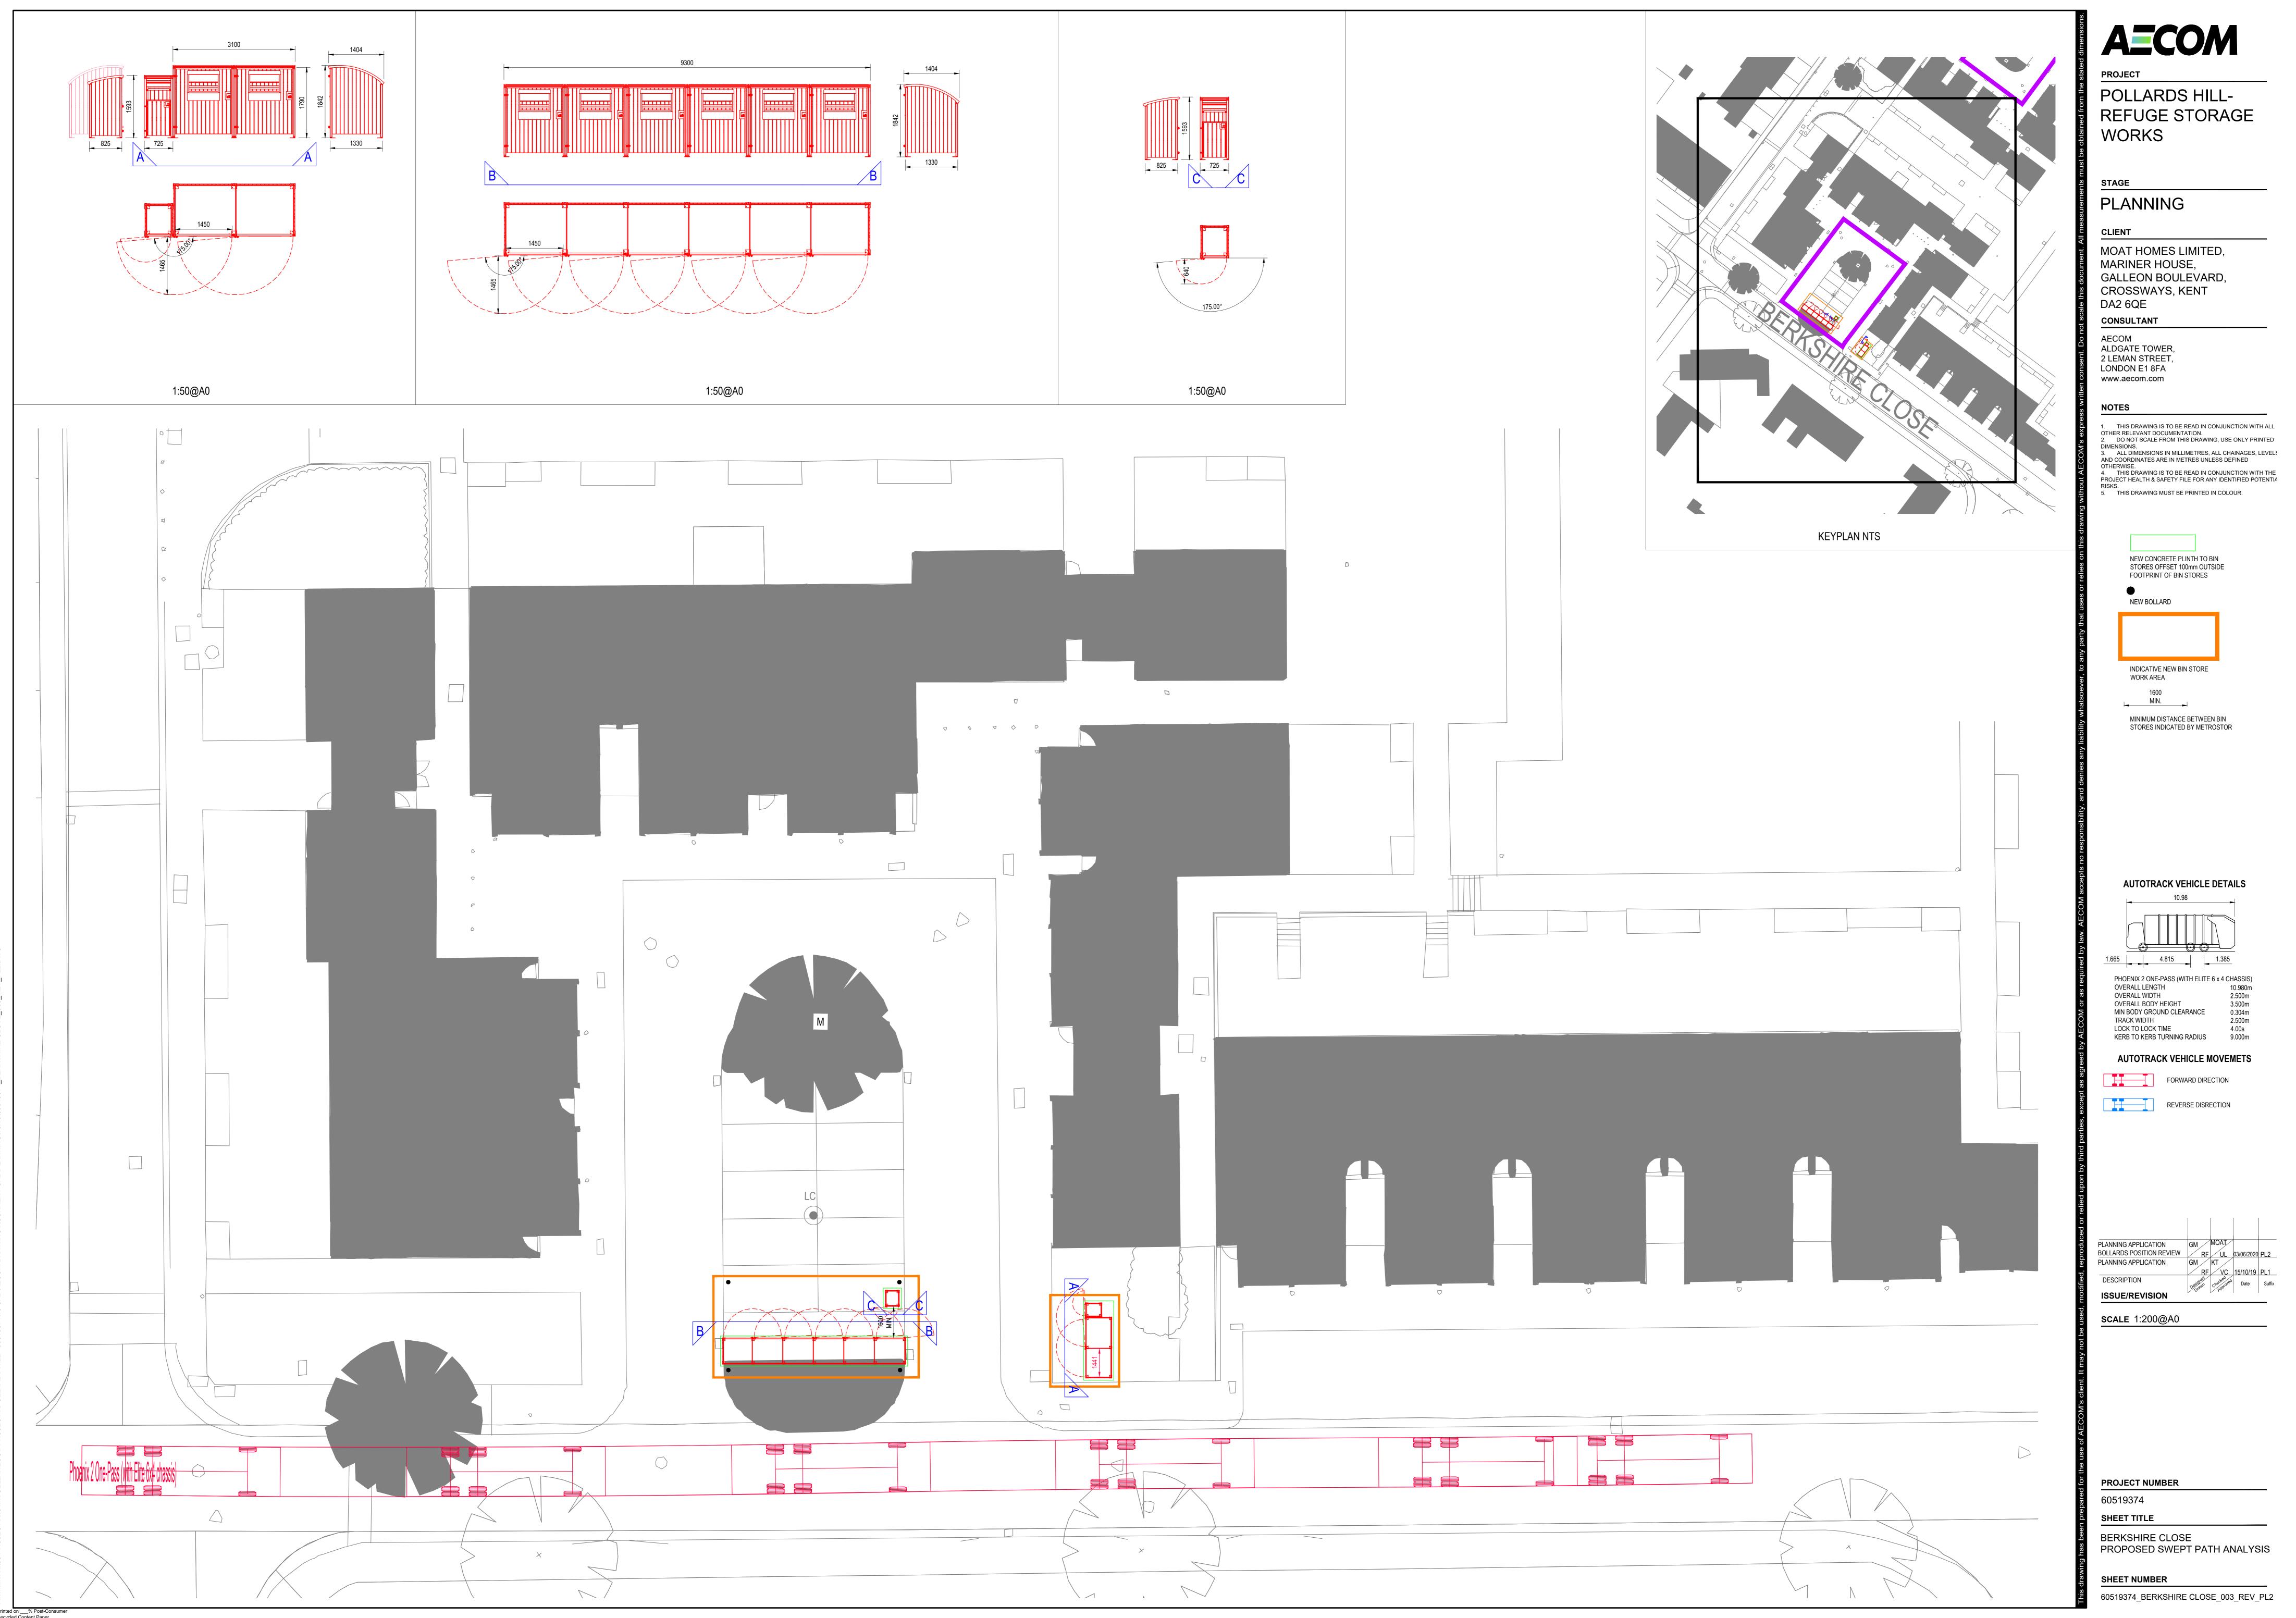

1. THIS DRAWING IS TO BE READ IN CONJUNCTION WITH ALL OTHER RELEVANT DOCUMENTATION.
2. DO NOT SCALE FROM THIS DRAWING, USE ONLY PRINTED 3. ALL DIMENSIONS IN MILLIMETRES, ALL CHAINAGES, LEVELS
AND COORDINATES ARE IN METRES UNLESS DEFINED

AUTOTRACK VEHICLE DETAILS

AUTOTRACK VEHICLE MOVEMETS

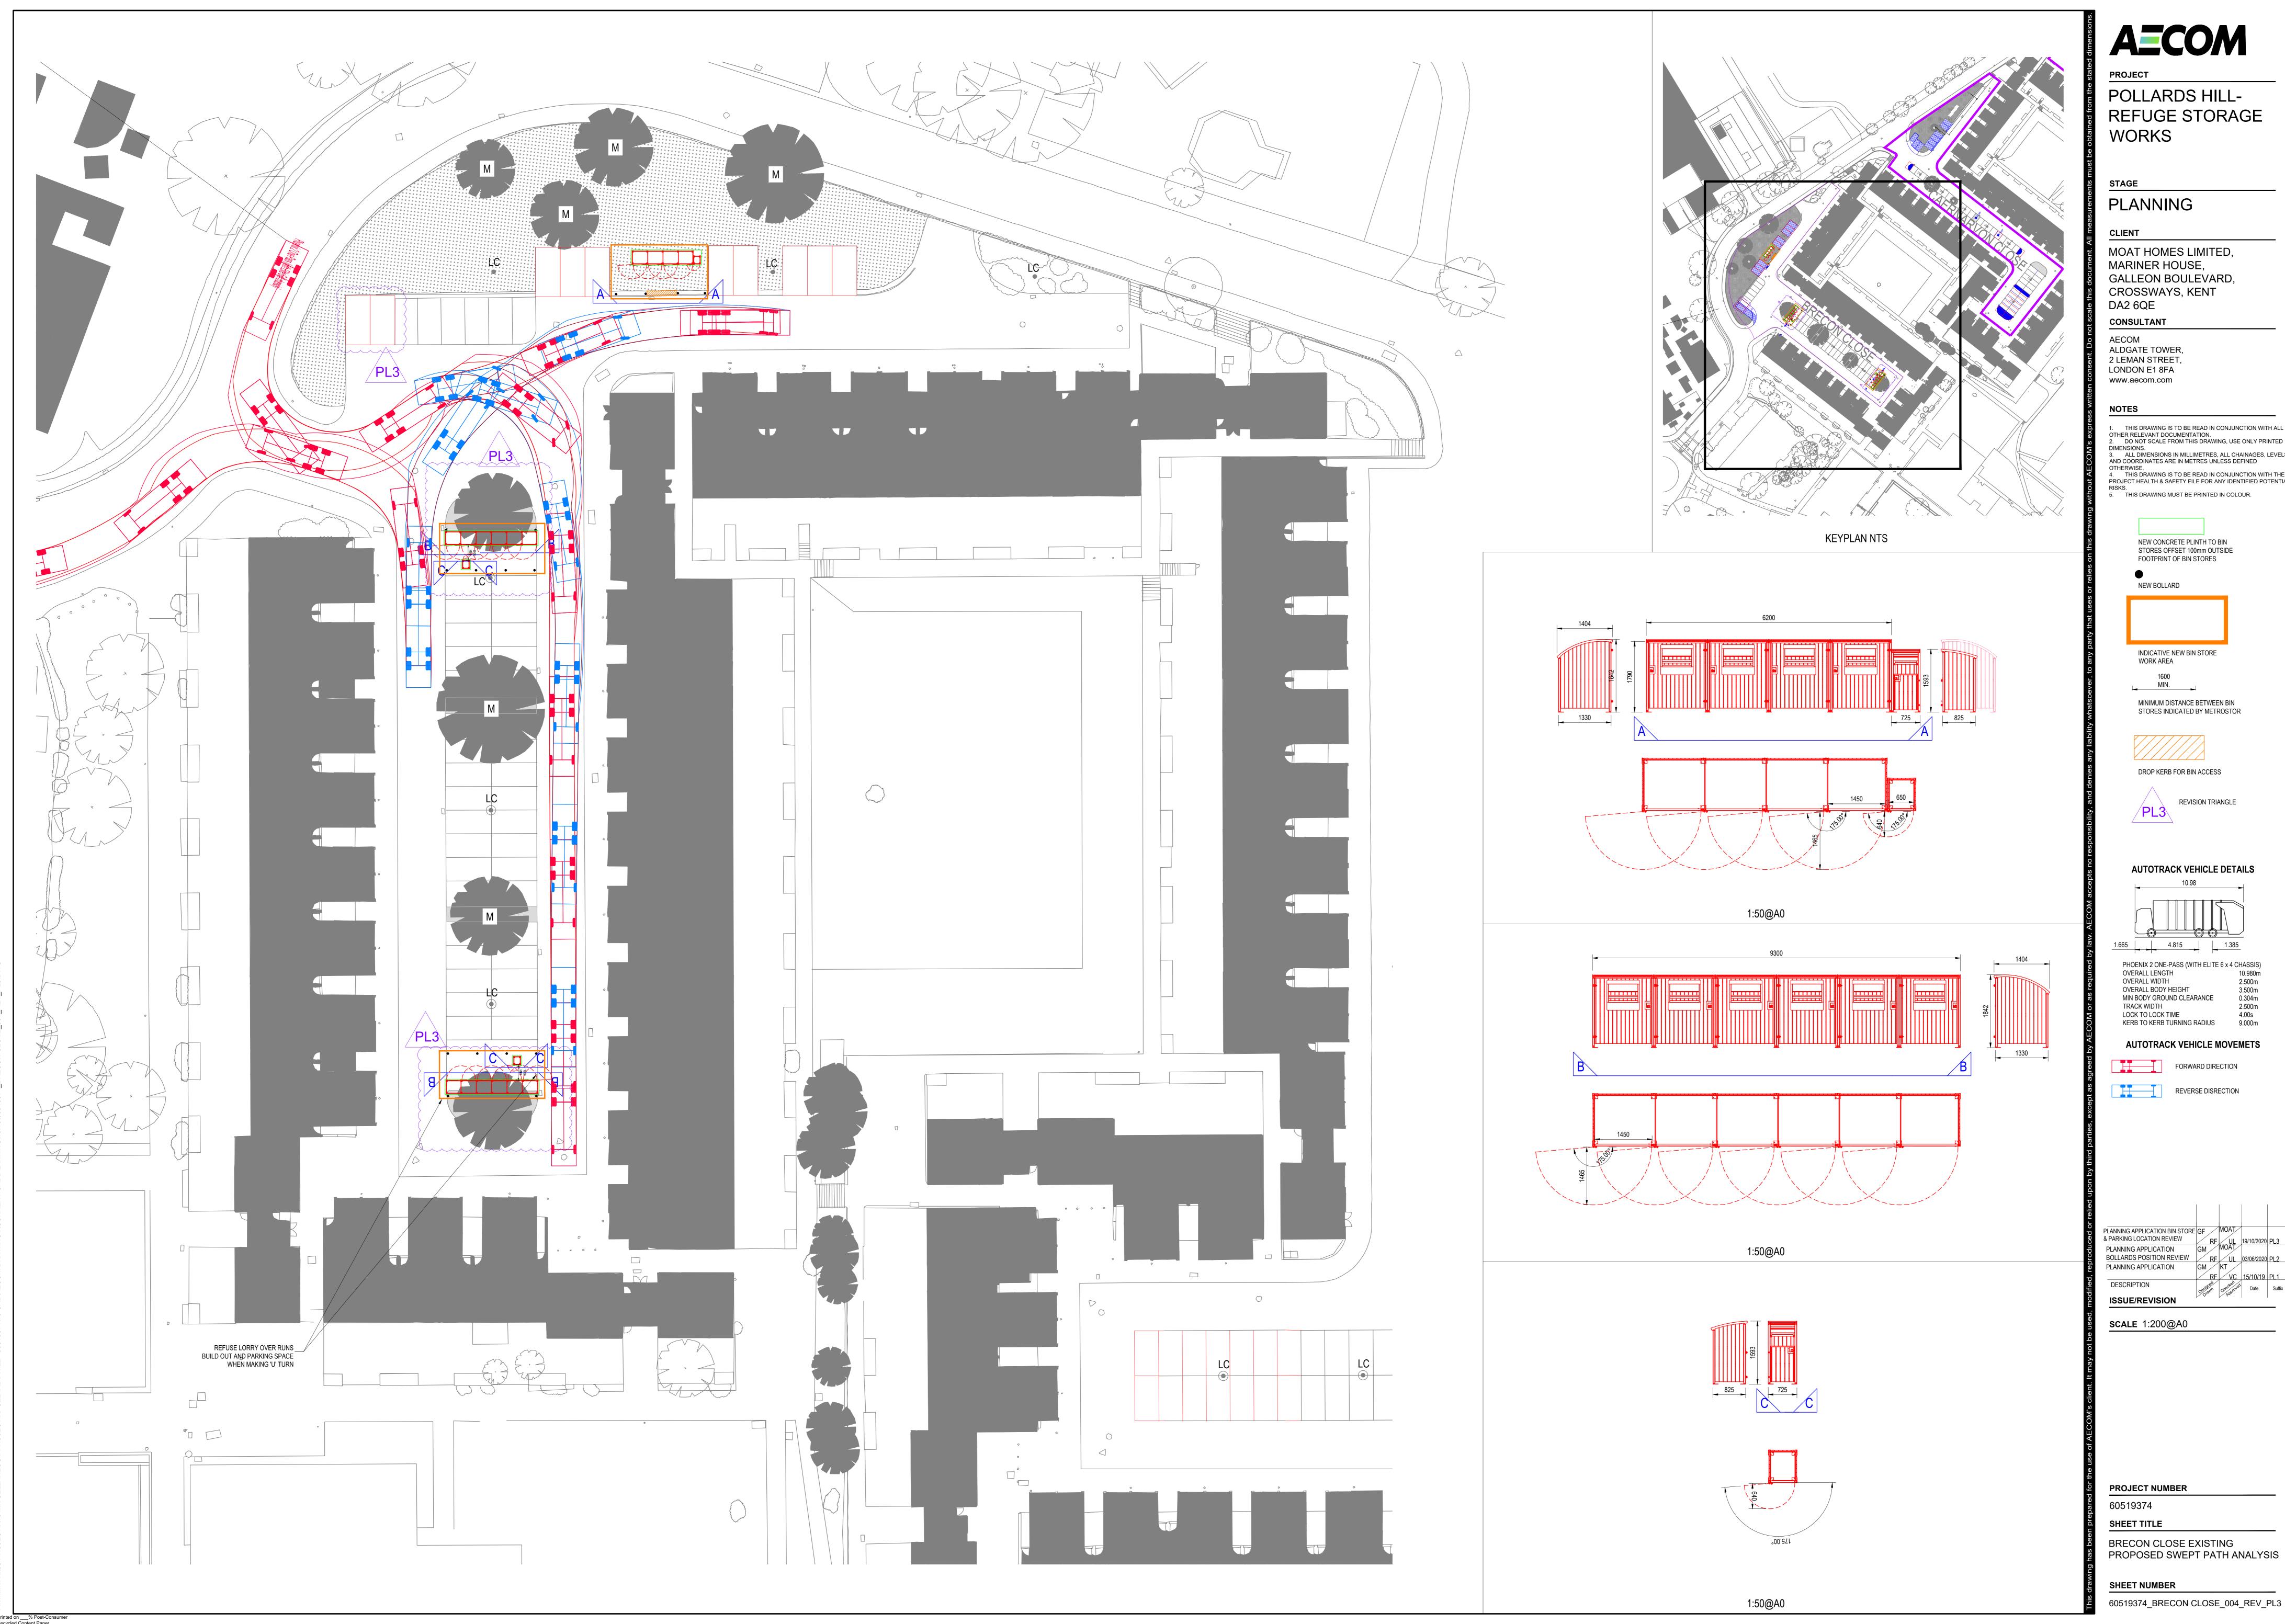

POLLARDS HILL-REFUGE STORAGE

MOAT HOMES LIMITED, GALLEON BOULEVARD, CROSSWAYS, KENT

 THIS DRAWING IS TO BE READ IN CONJUNCTION WITH ALL OTHER RELEVANT DOCUMENTATION.
 DO NOT SCALE FROM THIS DRAWING, USE ONLY PRINTED 3. ALL DIMENSIONS IN MILLIMETRES, ALL CHAINAGES, LEVELS AND COORDINATES ARE IN METRES UNLESS DEFINED


4. THIS DRAWING IS TO BE READ IN CONJUNCTION WITH THE PROJECT HEALTH & SAFETY FILE FOR ANY IDENTIFIED POTENTIF

NEW CONCRETE PLINTH TO BIN STORES OFFSET 100mm OUTSIDE


MINIMUM DISTANCE BETWEEN BIN STORES INDICATED BY METROSTOR



REVISION TRIANGLE

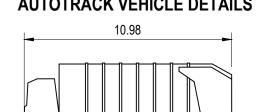

AUTOTRACK VEHICLE MOVEMETS

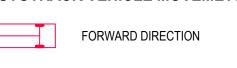

PLANNING APPLICATION REVIEW

PLANNING APPLICATION

BOLLARDS POSITION REVIEW

PLANNING APPLICATION


GM MOAT

RF UL 03/06/2020 PL2

PLANNING APPLICATION

GM KT


60519374_BRECON CLOSE_004_REV_PL3

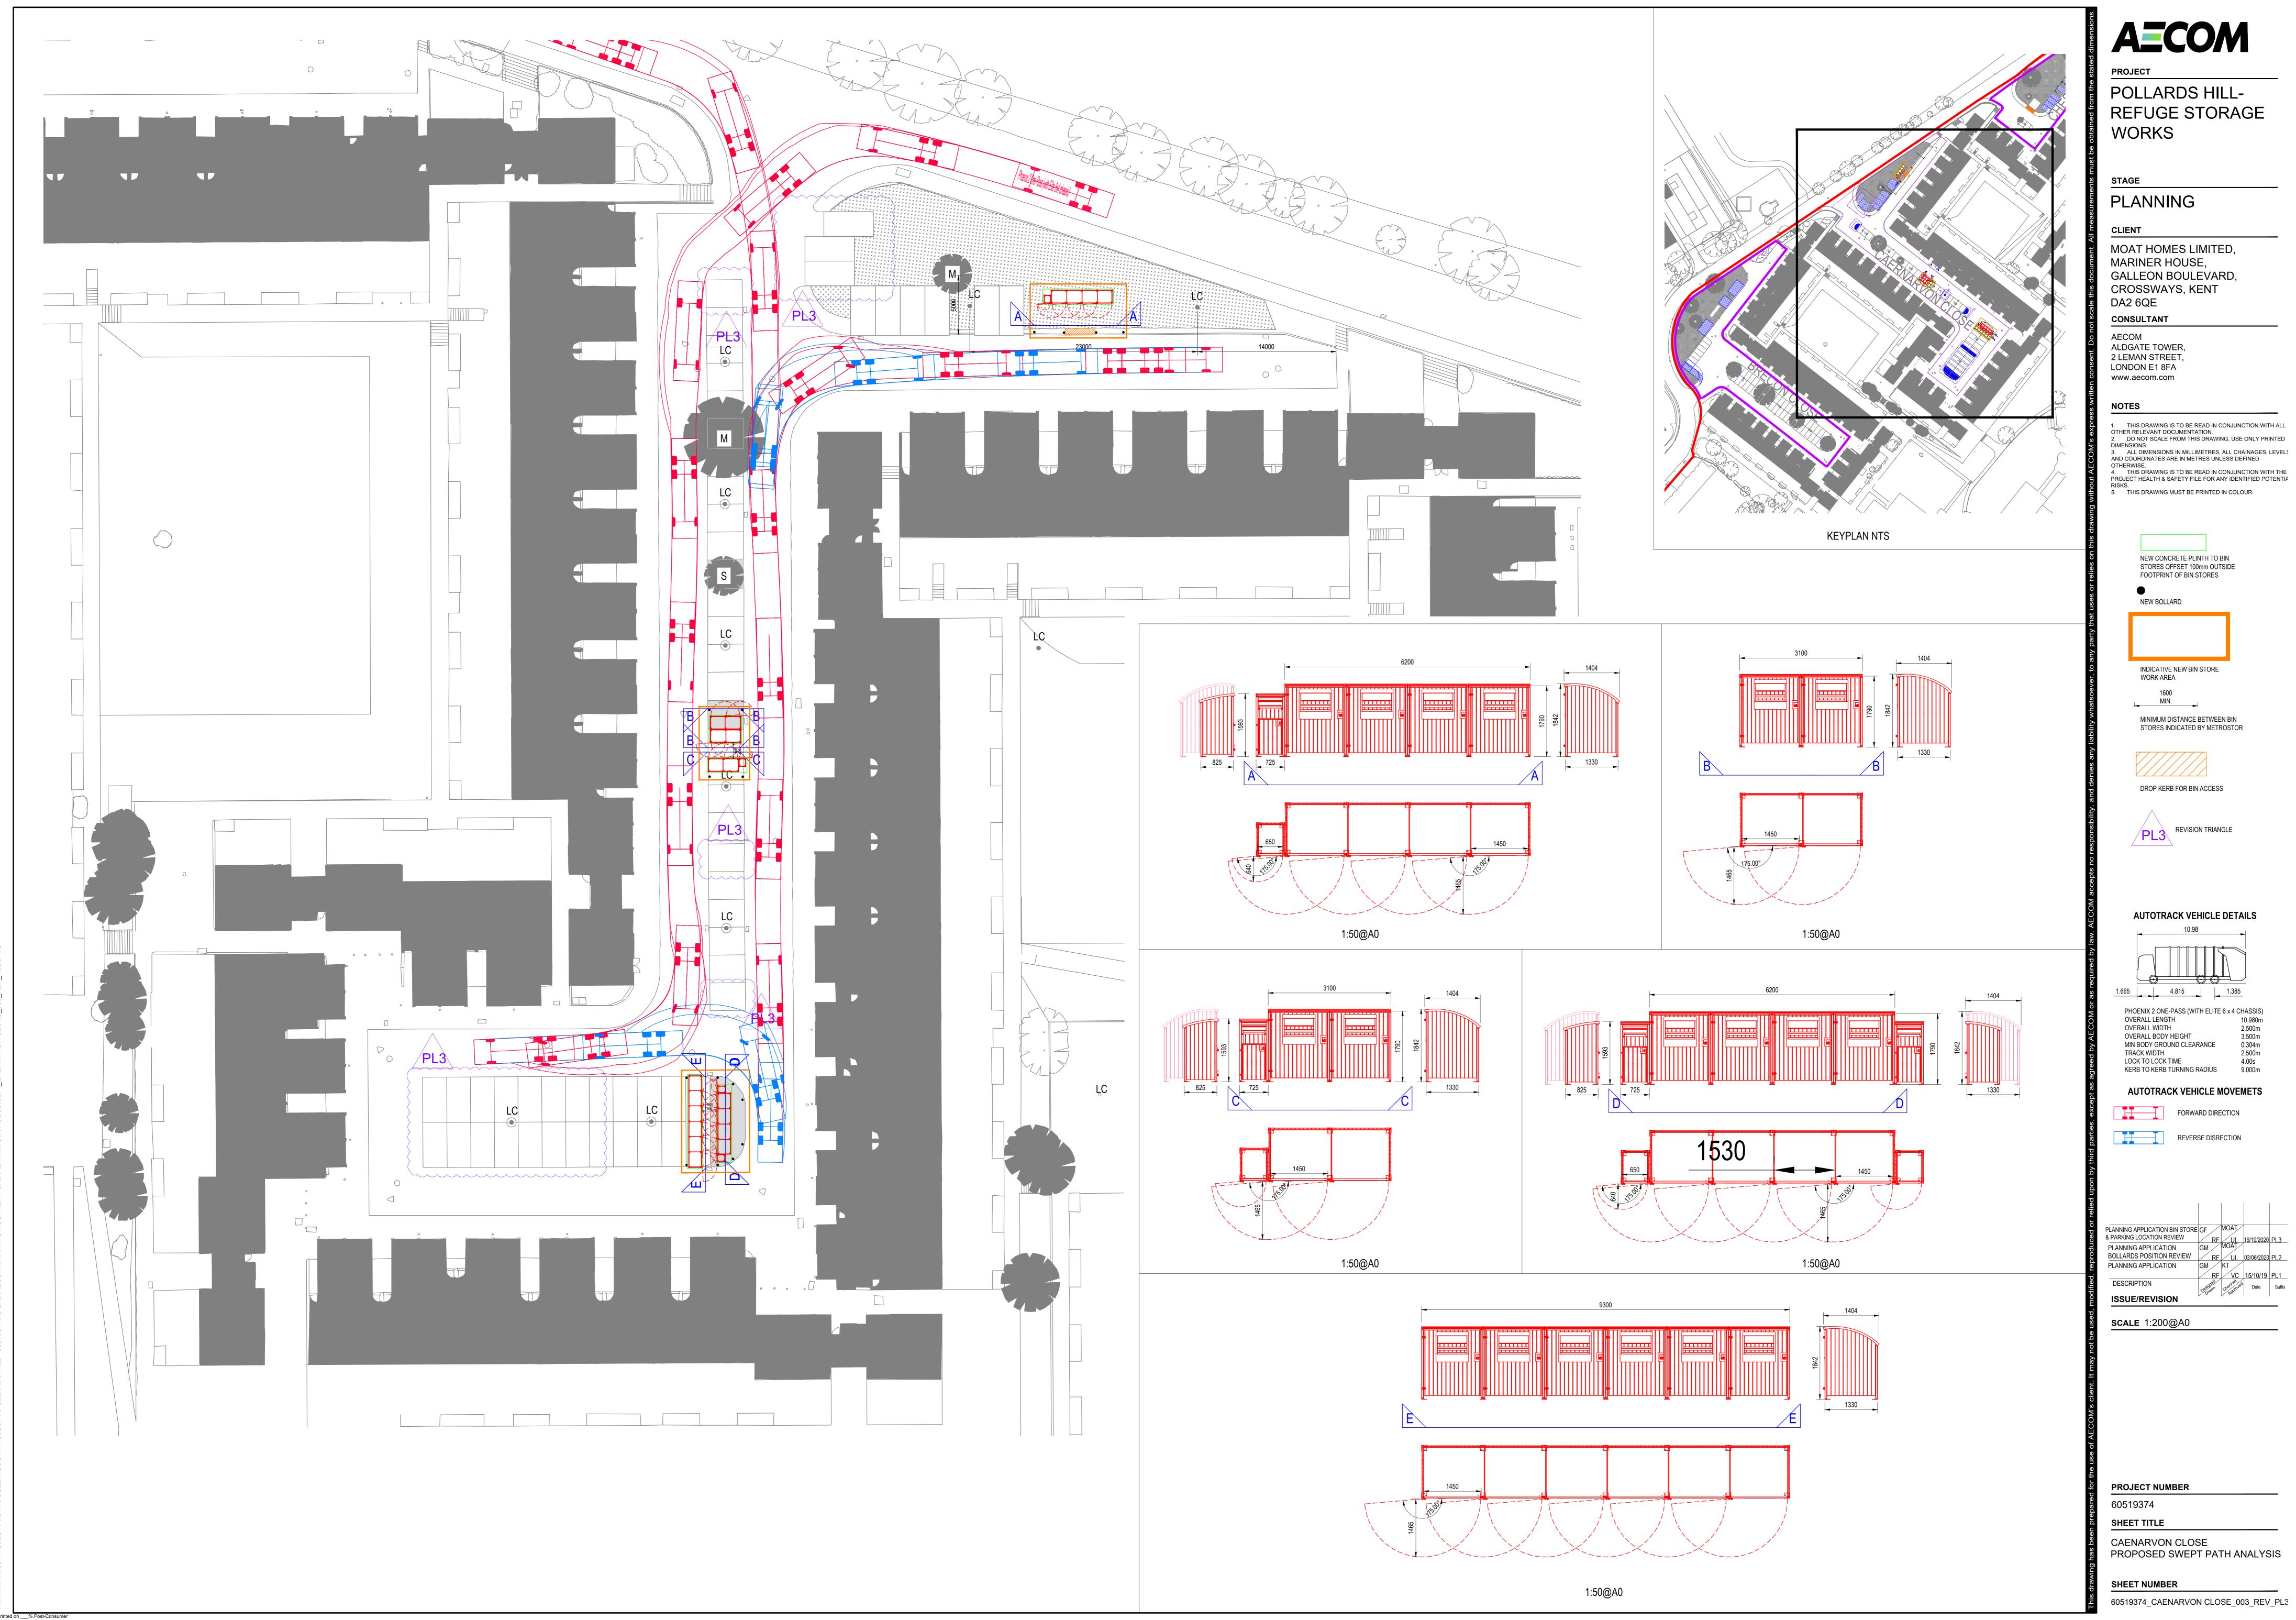

 THIS DRAWING IS TO BE READ IN CONJUNCTION WITH ALL OTHER RELEVANT DOCUMENTATION.
 DO NOT SCALE FROM THIS DRAWING, USE ONLY PRINTED 3. ALL DIMENSIONS IN MILLIMETRES, ALL CHAINAGES, LEVELS AND COORDINATES ARE IN METRES UNLESS DEFINED

AUTOTRACK VEHICLE DETAILS

& PARKING LOCATION REVIEW RF UL 19/10/2020 PL3
PLANNING APPLICATION GM MOAT
BOLLARDS POSITION REVIEW RF UL 03/06/2020 PL2
PLANNING APPLICATION GM KT

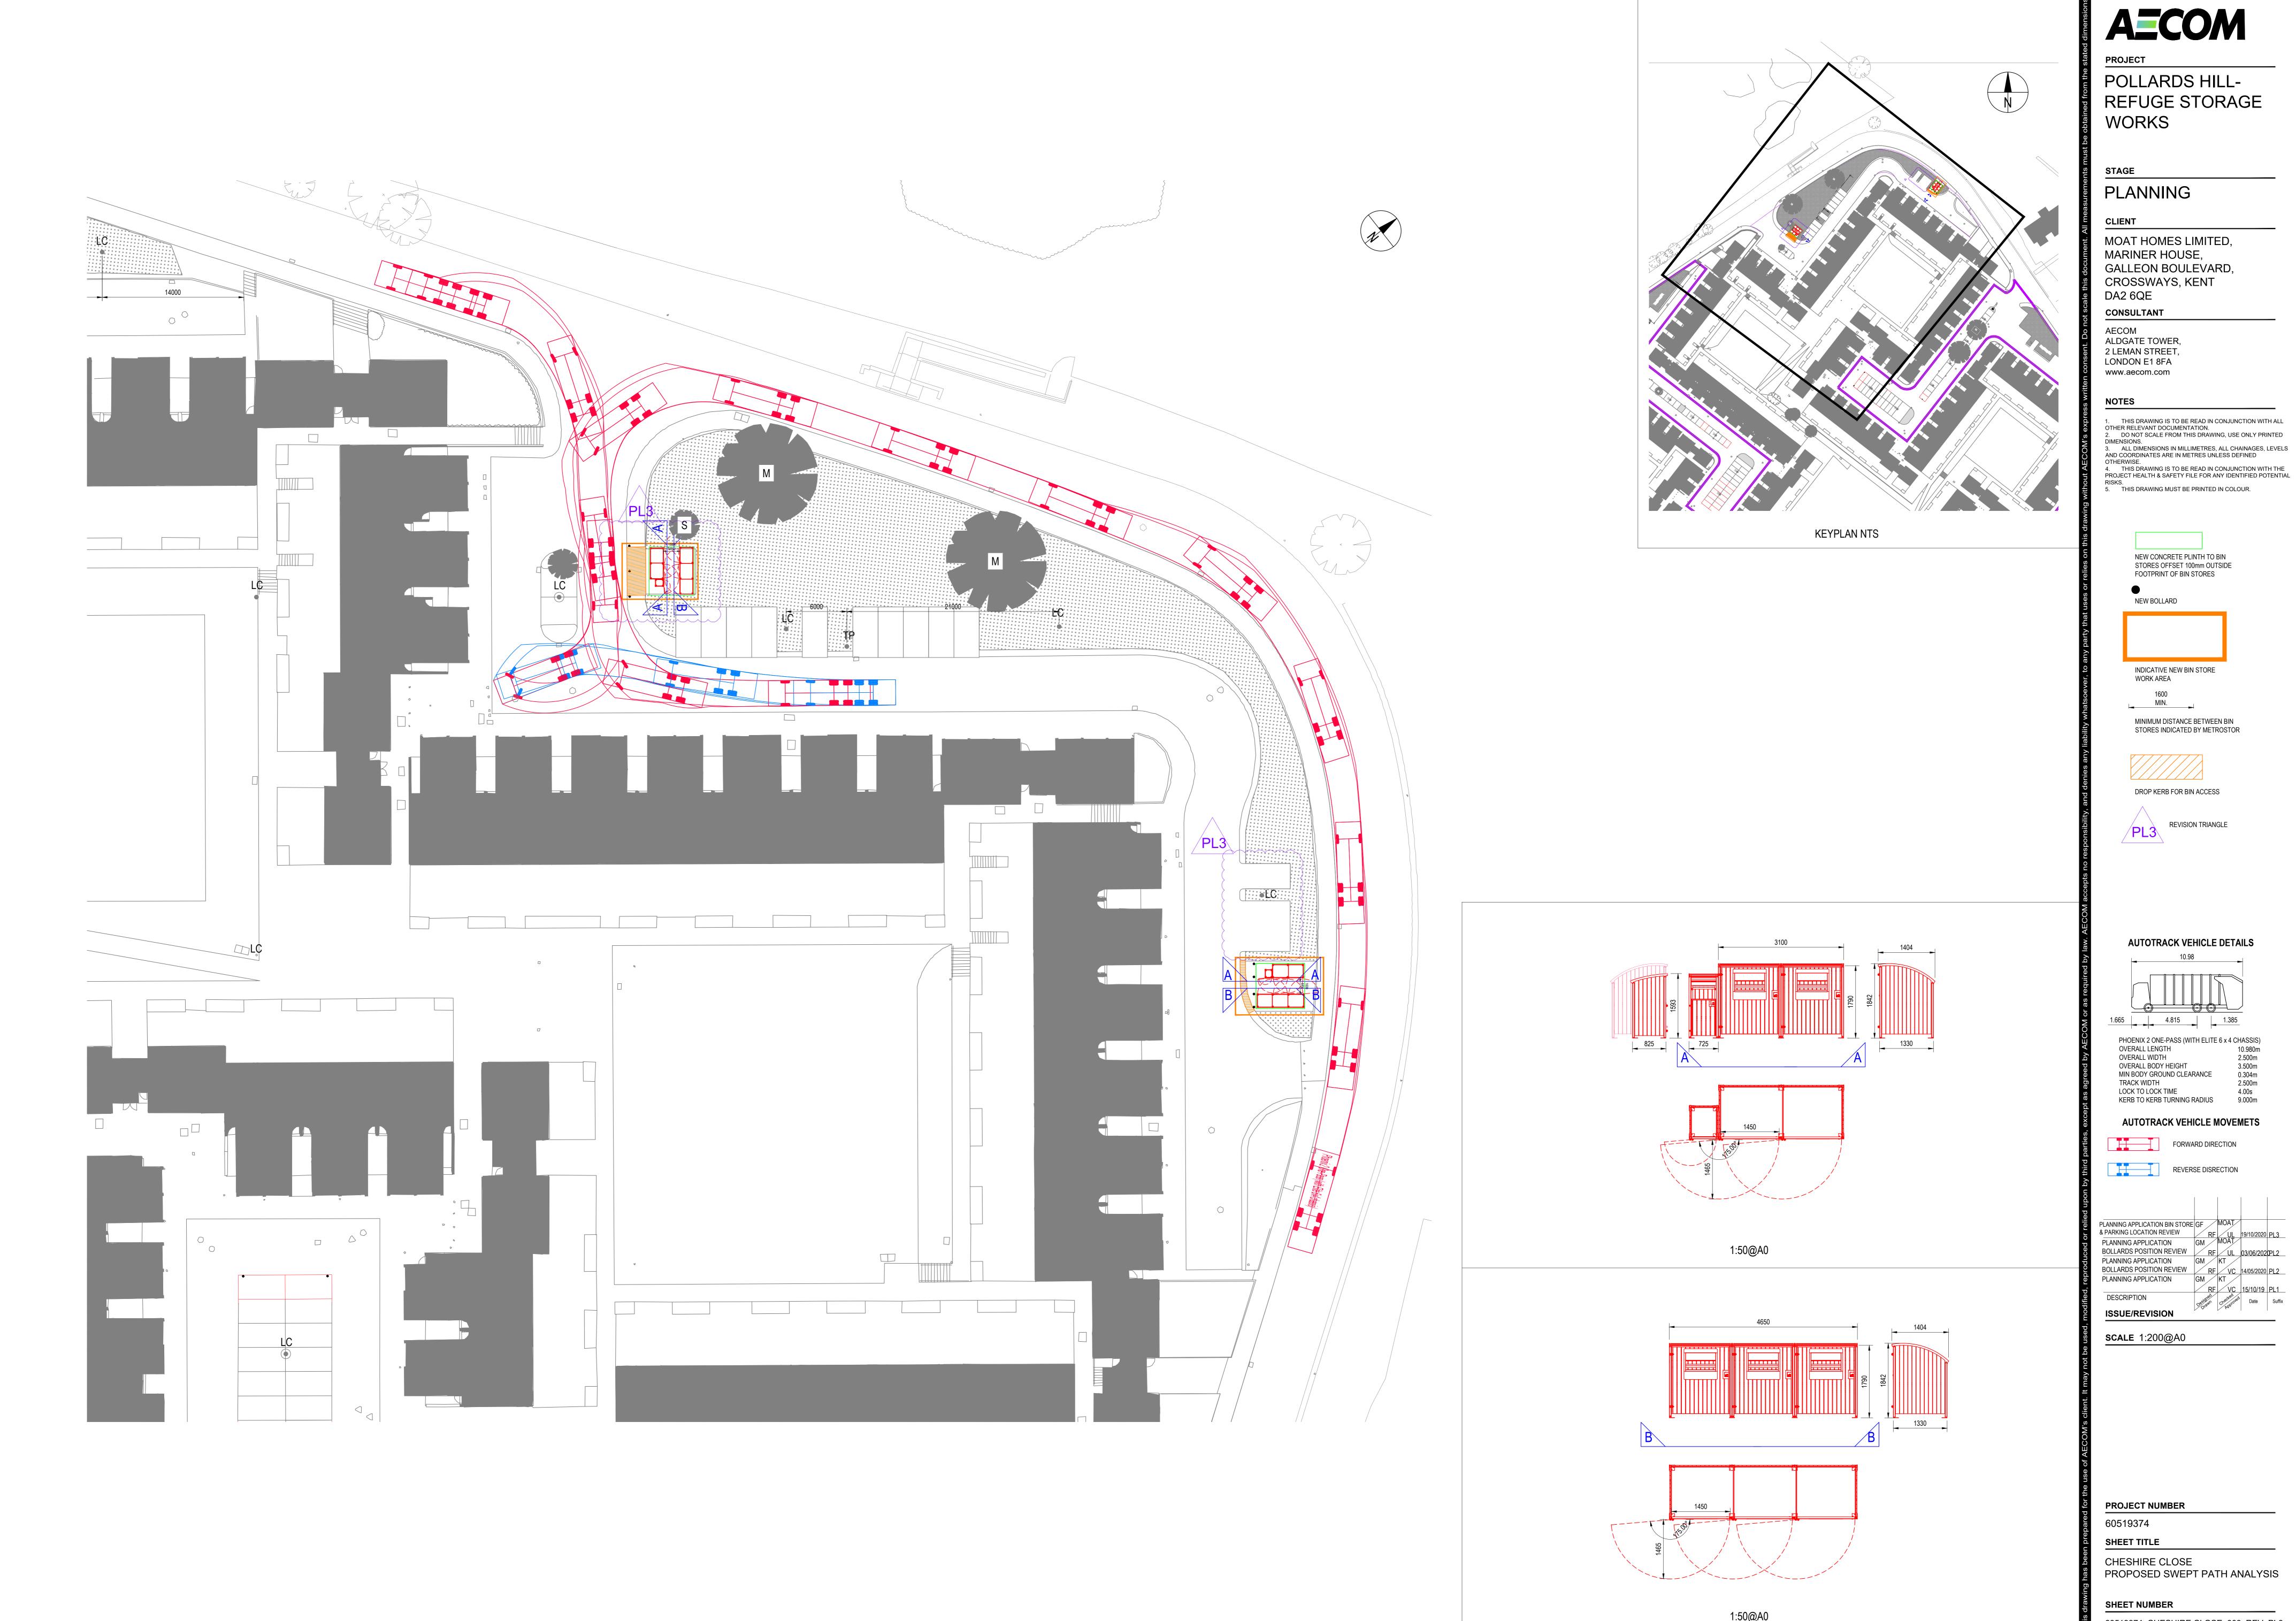

PLANNING

CLIENT

MOAT HOMES LIMITED, MARINER HOUSE, GALLEON BOULEVARD, CROSSWAYS, KENT DA2 6QE

CONSULTANT

ALDGATE TOWER, 2 LEMAN STREET, LONDON E1 8FA www.aecom.com

 THIS DRAWING IS TO BE READ IN CONJUNCTION WITH ALL OTHER RELEVANT DOCUMENTATION.
 DO NOT SCALE FROM THIS DRAWING, USE ONLY PRINTED 3. ALL DIMENSIONS IN MILLIMETRES, ALL CHAINAGES, LEVELS
AND COURT OF THE PROPERTY OF THE PROPE

5. THIS DRAWING MUST BE PRINTED IN COLOUR.

NEW CONCRETE PLINTH TO BIN STORES OFFSET 100mm OUTSIDE FOOTPRINT OF BIN STORES

NEW BOLLARD

INDICATIVE NEW BIN STORE WORK AREA

MINIMUM DISTANCE BETWEEN BIN STORES INDICATED BY METROSTOR

DROP KERB FOR BIN ACCESS

AUTOTRACK VEHICLE DETAILS

PHOENIX 2 ONE-PASS (WITH ELITE 6 x 4 CHASSIS)
OVERALL LENGTH 10.980m
OVERALL WIDTH 2.500m
OVERALL BODY HEIGHT 3.500m
MIN BODY GROUND CLEARANCE 0.304m
TRACK WIDTH 2.500m
LOCK TO LOCK TIME 4.00s
KERB TO KERB TURNING RADIUS 9.000m

AUTOTRACK VEHICLE MOVEMETS

FORWARD DIRECTION REVERSE DISRECTION

PLANNING APPLICATION BIN STORE GF MOAT & PARKING LOCATION REVIEW RF UL 19/10/2020 PL3 PLANNING APPLICATION GM MOAT

BOLLARDS POSITION REVIEW RF UL 03/06/2020PL2
PLANNING APPLICATION GM KT
BOLLARDS POSITION REVIEW RF VC 14/05/2020 PL2 PLANNING APPLICATION


ISSUE/REVISION

SCALE 1:200@A0

SHEET TITLE

CHESHIRE CLOSE PROPOSED SWEPT PATH ANALYSIS

SHEET NUMBER 60519374_CHESHIRE CLOSE_003_REV_PL3

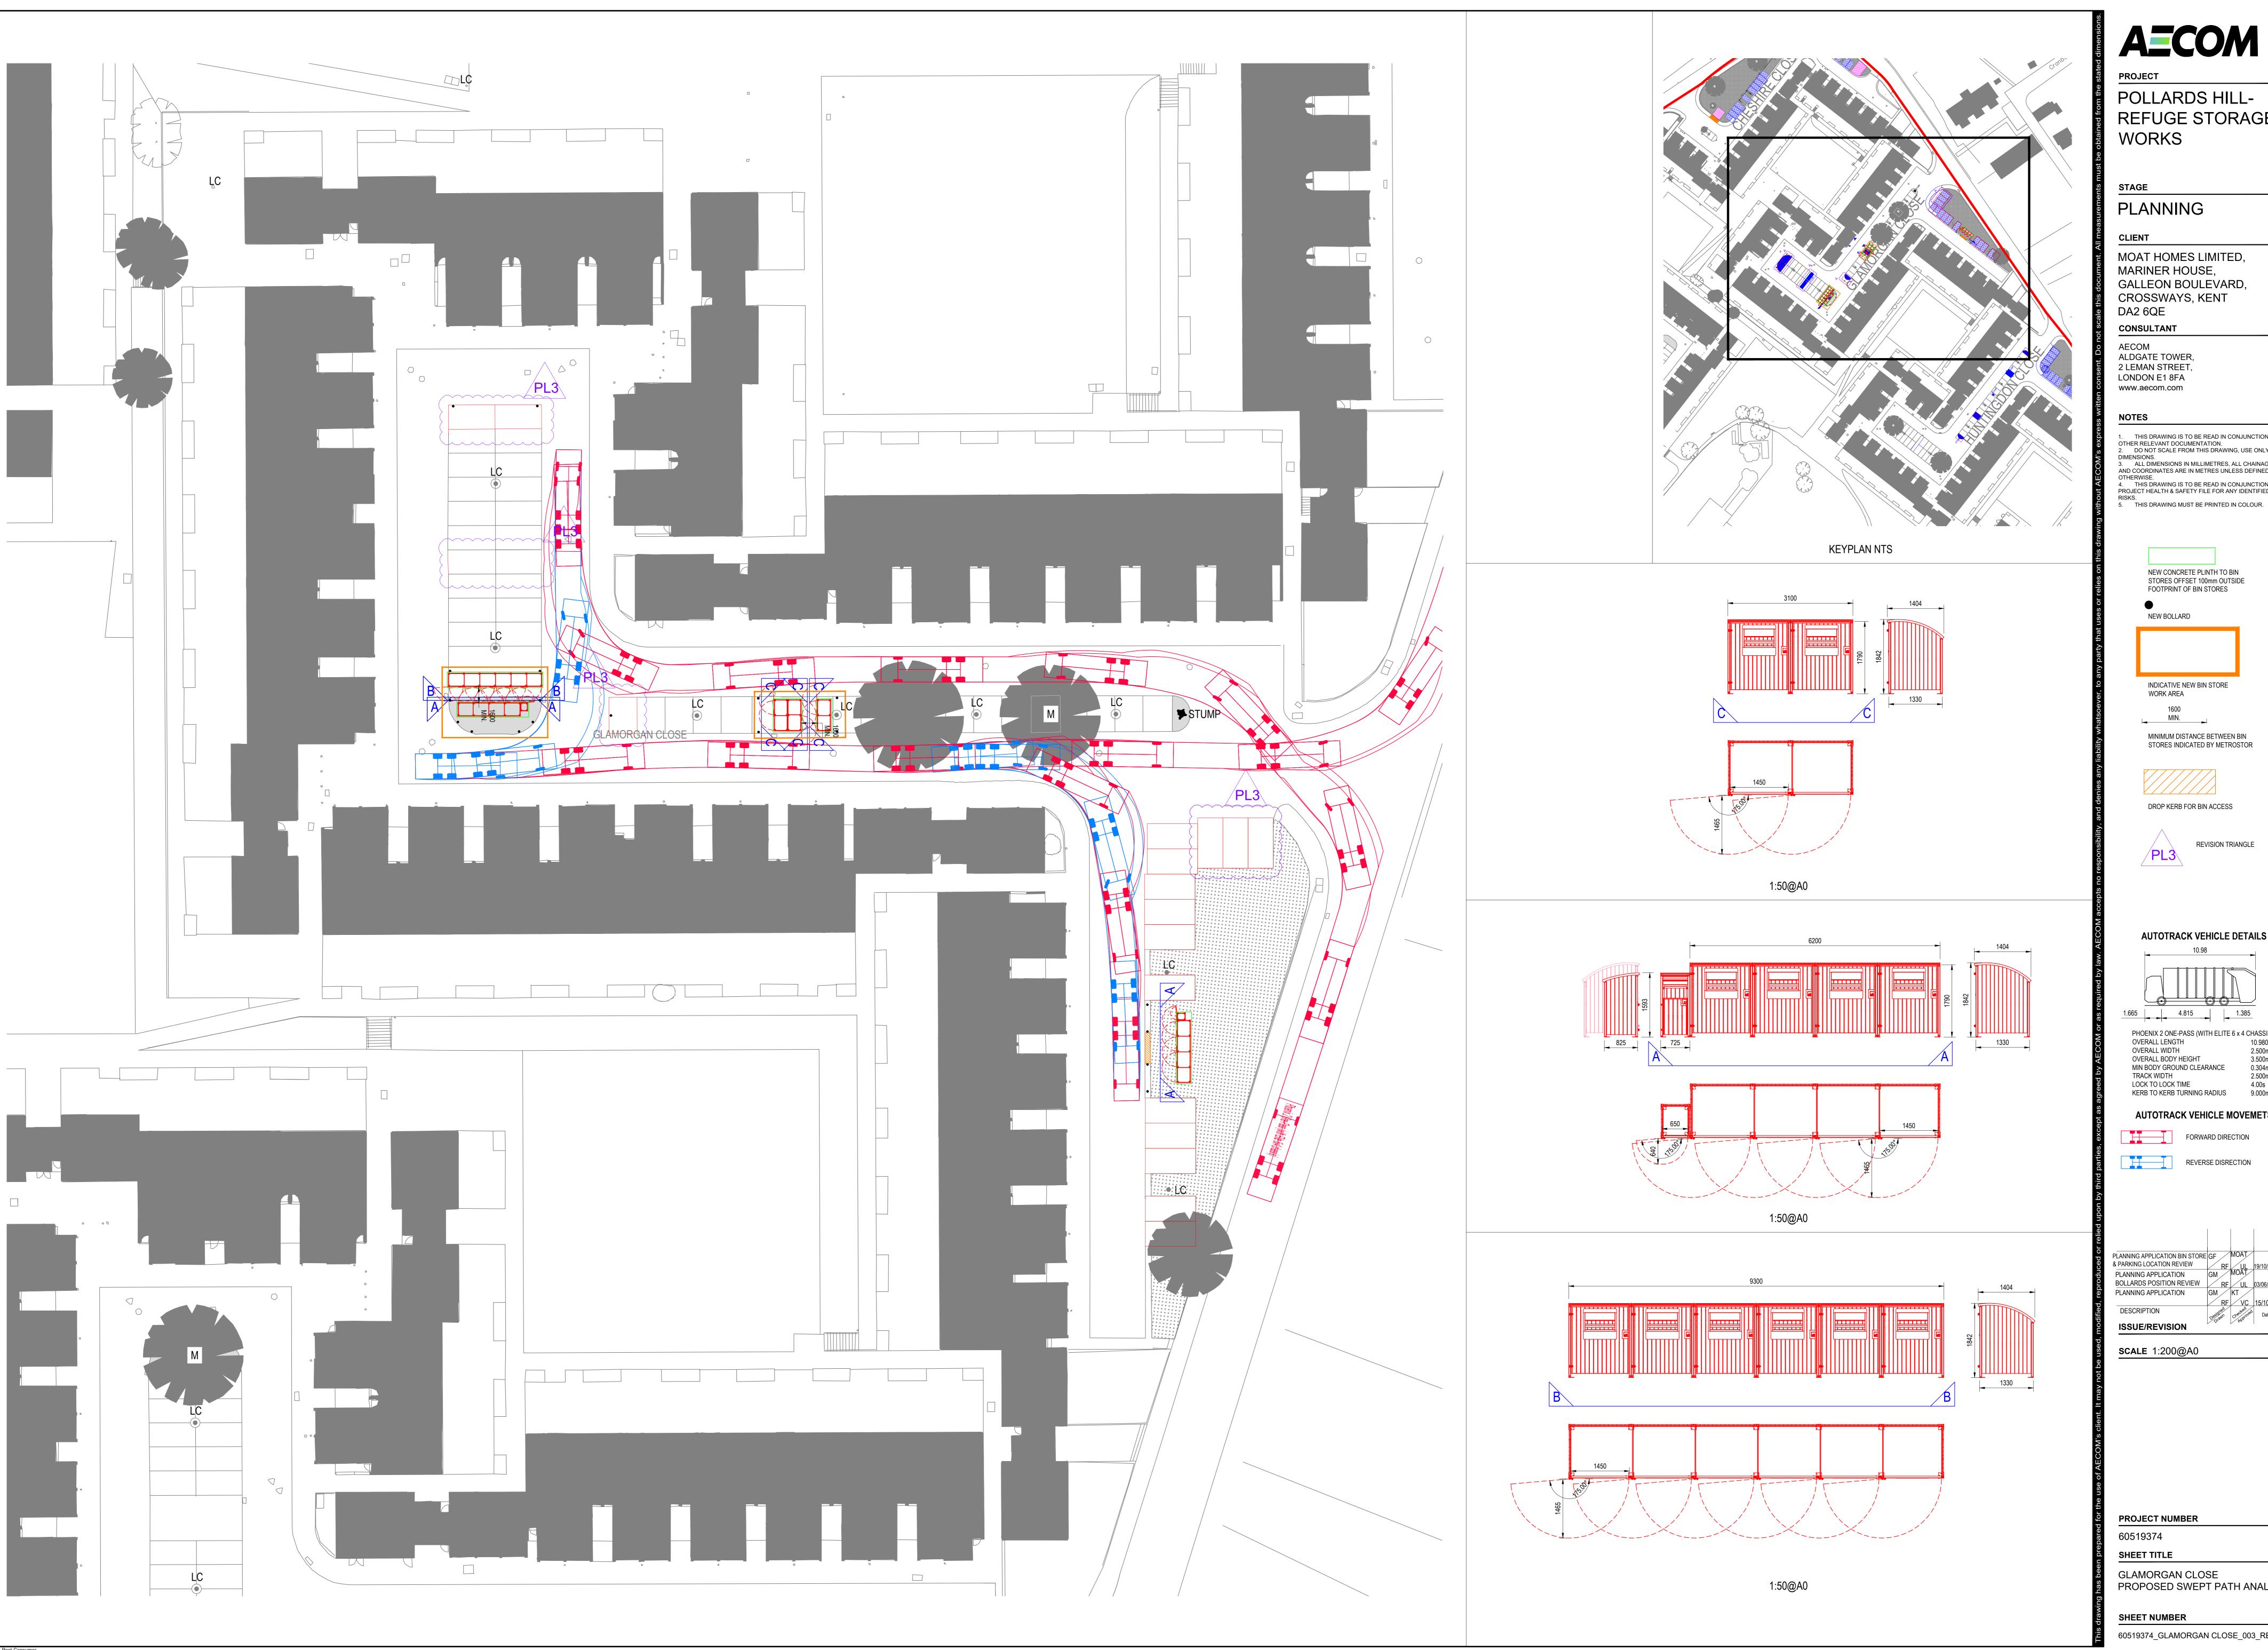

POLLARDS HILL-REFUGE STORAGE

MOAT HOMES LIMITED, MARINER HOUSE, GALLEON BOULEVARD, CROSSWAYS, KENT

ALDGATE TOWER, 2 LEMAN STREET, LONDON E1 8FA www.aecom.com

 THIS DRAWING IS TO BE READ IN CONJUNCTION WITH ALL OTHER RELEVANT DOCUMENTATION.
 DO NOT SCALE FROM THIS DRAWING, USE ONLY PRINTED 3. ALL DIMENSIONS IN MILLIMETRES, ALL CHAINAGES, LEVELS
AND COORDINATES ARE IN METRES UNLESS DEFINED 4. THIS DRAWING IS TO BE READ IN CONJUNCTION WITH THE PROJECT HEALTH & SAFETY FILE FOR ANY IDENTIFIED POTENTIF

> NEW CONCRETE PLINTH TO BIN STORES OFFSET 100mm OUTSIDE FOOTPRINT OF BIN STORES

INDICATIVE NEW BIN STORE WORK AREA

MINIMUM DISTANCE BETWEEN BIN

DROP KERB FOR BIN ACCESS

AUTOTRACK VEHICLE DETAILS

OVERALL LENGTH
OVERALL WIDTH
OVERALL BODY HEIGHT
MIN BODY GROUND CLEARANCE
TRACK WIDTH
LOCK TO LOCK TIME
KERB TO KERB TURNING RADIUS

AUTOTRACK VEHICLE MOVEMETS

REVERSE DISRECTION

PLANNING APPLICATION
BOLLARDS POSITION REVIEW PLANNING APPLICATION

ISSUE/REVISION


SCALE 1:200@A0

PROJECT NUMBER

SHEET TITLE

GLAMORGAN CLOSE PROPOSED SWEPT PATH ANALYSIS

60519374_GLAMORGAN CLOSE_003_REV_PL3

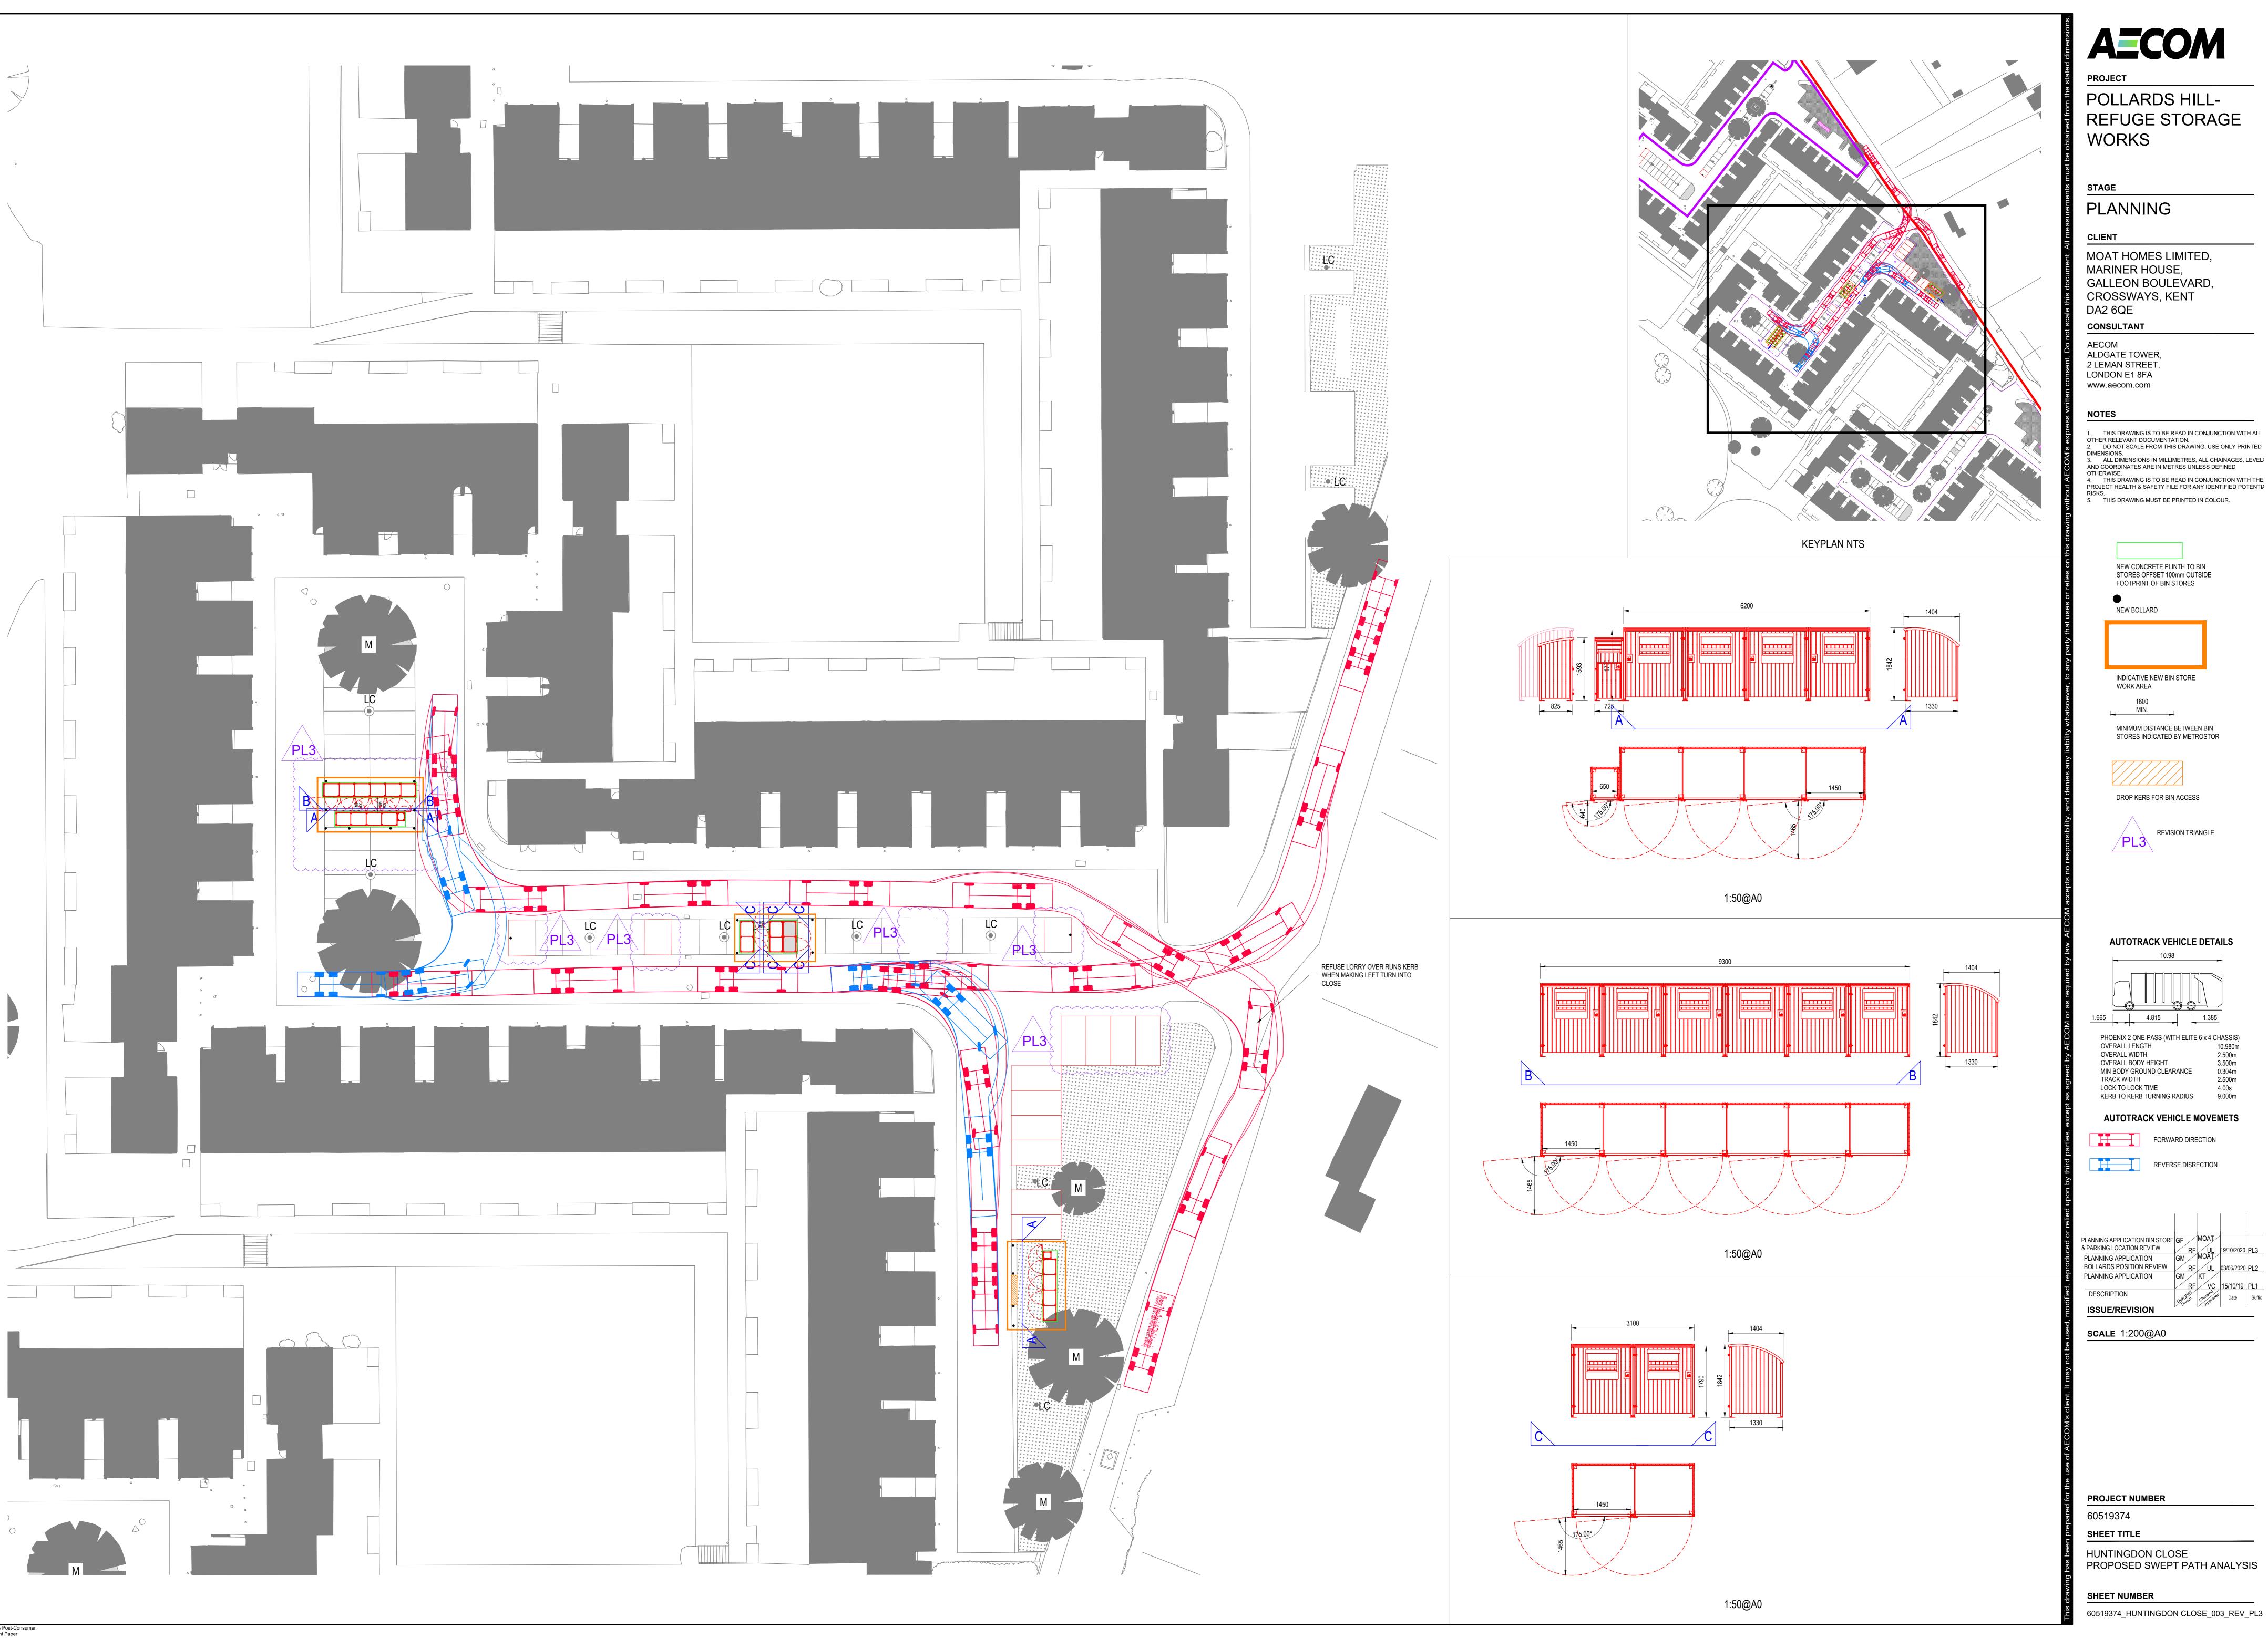

POLLARDS HILL-REFUGE STORAGE WORKS

PLANNING

MOAT HOMES LIMITED, MARINER HOUSE, GALLEON BOULEVARD, CROSSWAYS, KENT DA2 6QE

CONSULTANT ALDGATE TOWER,

www.aecom.com

1. THIS DRAWING IS TO BE READ IN CONJUNCTION WITH ALL OTHER RELEVANT DOCUMENTATION.
2. DO NOT SCALE FROM THIS DRAWING, USE ONLY PRINTED 3. ALL DIMENSIONS IN MILLIMETRES, ALL CHAINAGES, LEVELS AND COORDINATES ARE IN METRES UNLESS DEFINED 4. THIS DRAWING IS TO BE READ IN CONJUNCTION WITH THE

> NEW CONCRETE PLINTH TO BIN STORES OFFSET 100mm OUTSIDE FOOTPRINT OF BIN STORES

NEW BOLLARD

INDICATIVE NEW BIN STORE WORK AREA

MINIMUM DISTANCE BETWEEN BIN STORES INDICATED BY METROSTOR

DROP KERB FOR BIN ACCESS

AUTOTRACK VEHICLE DETAILS

OVERALL BODY HEIGHT MIN BODY GROUND CLEARANCE

LOCK TO LOCK TIME KERB TO KERB TURNING RADIUS AUTOTRACK VEHICLE MOVEMETS

REVERSE DISRECTION

PLANNING APPLICATION BOLLARDS POSITION REVIEW PLANNING APPLICATION

ISSUE/REVISION


SCALE 1:200@A0

PROJECT NUMBER

SHEET TITLE

HUNTINGDON CLOSE PROPOSED SWEPT PATH ANALYSIS

SHEET NUMBER 60519374_HUNTINGDON CLOSE_003_REV_PL3

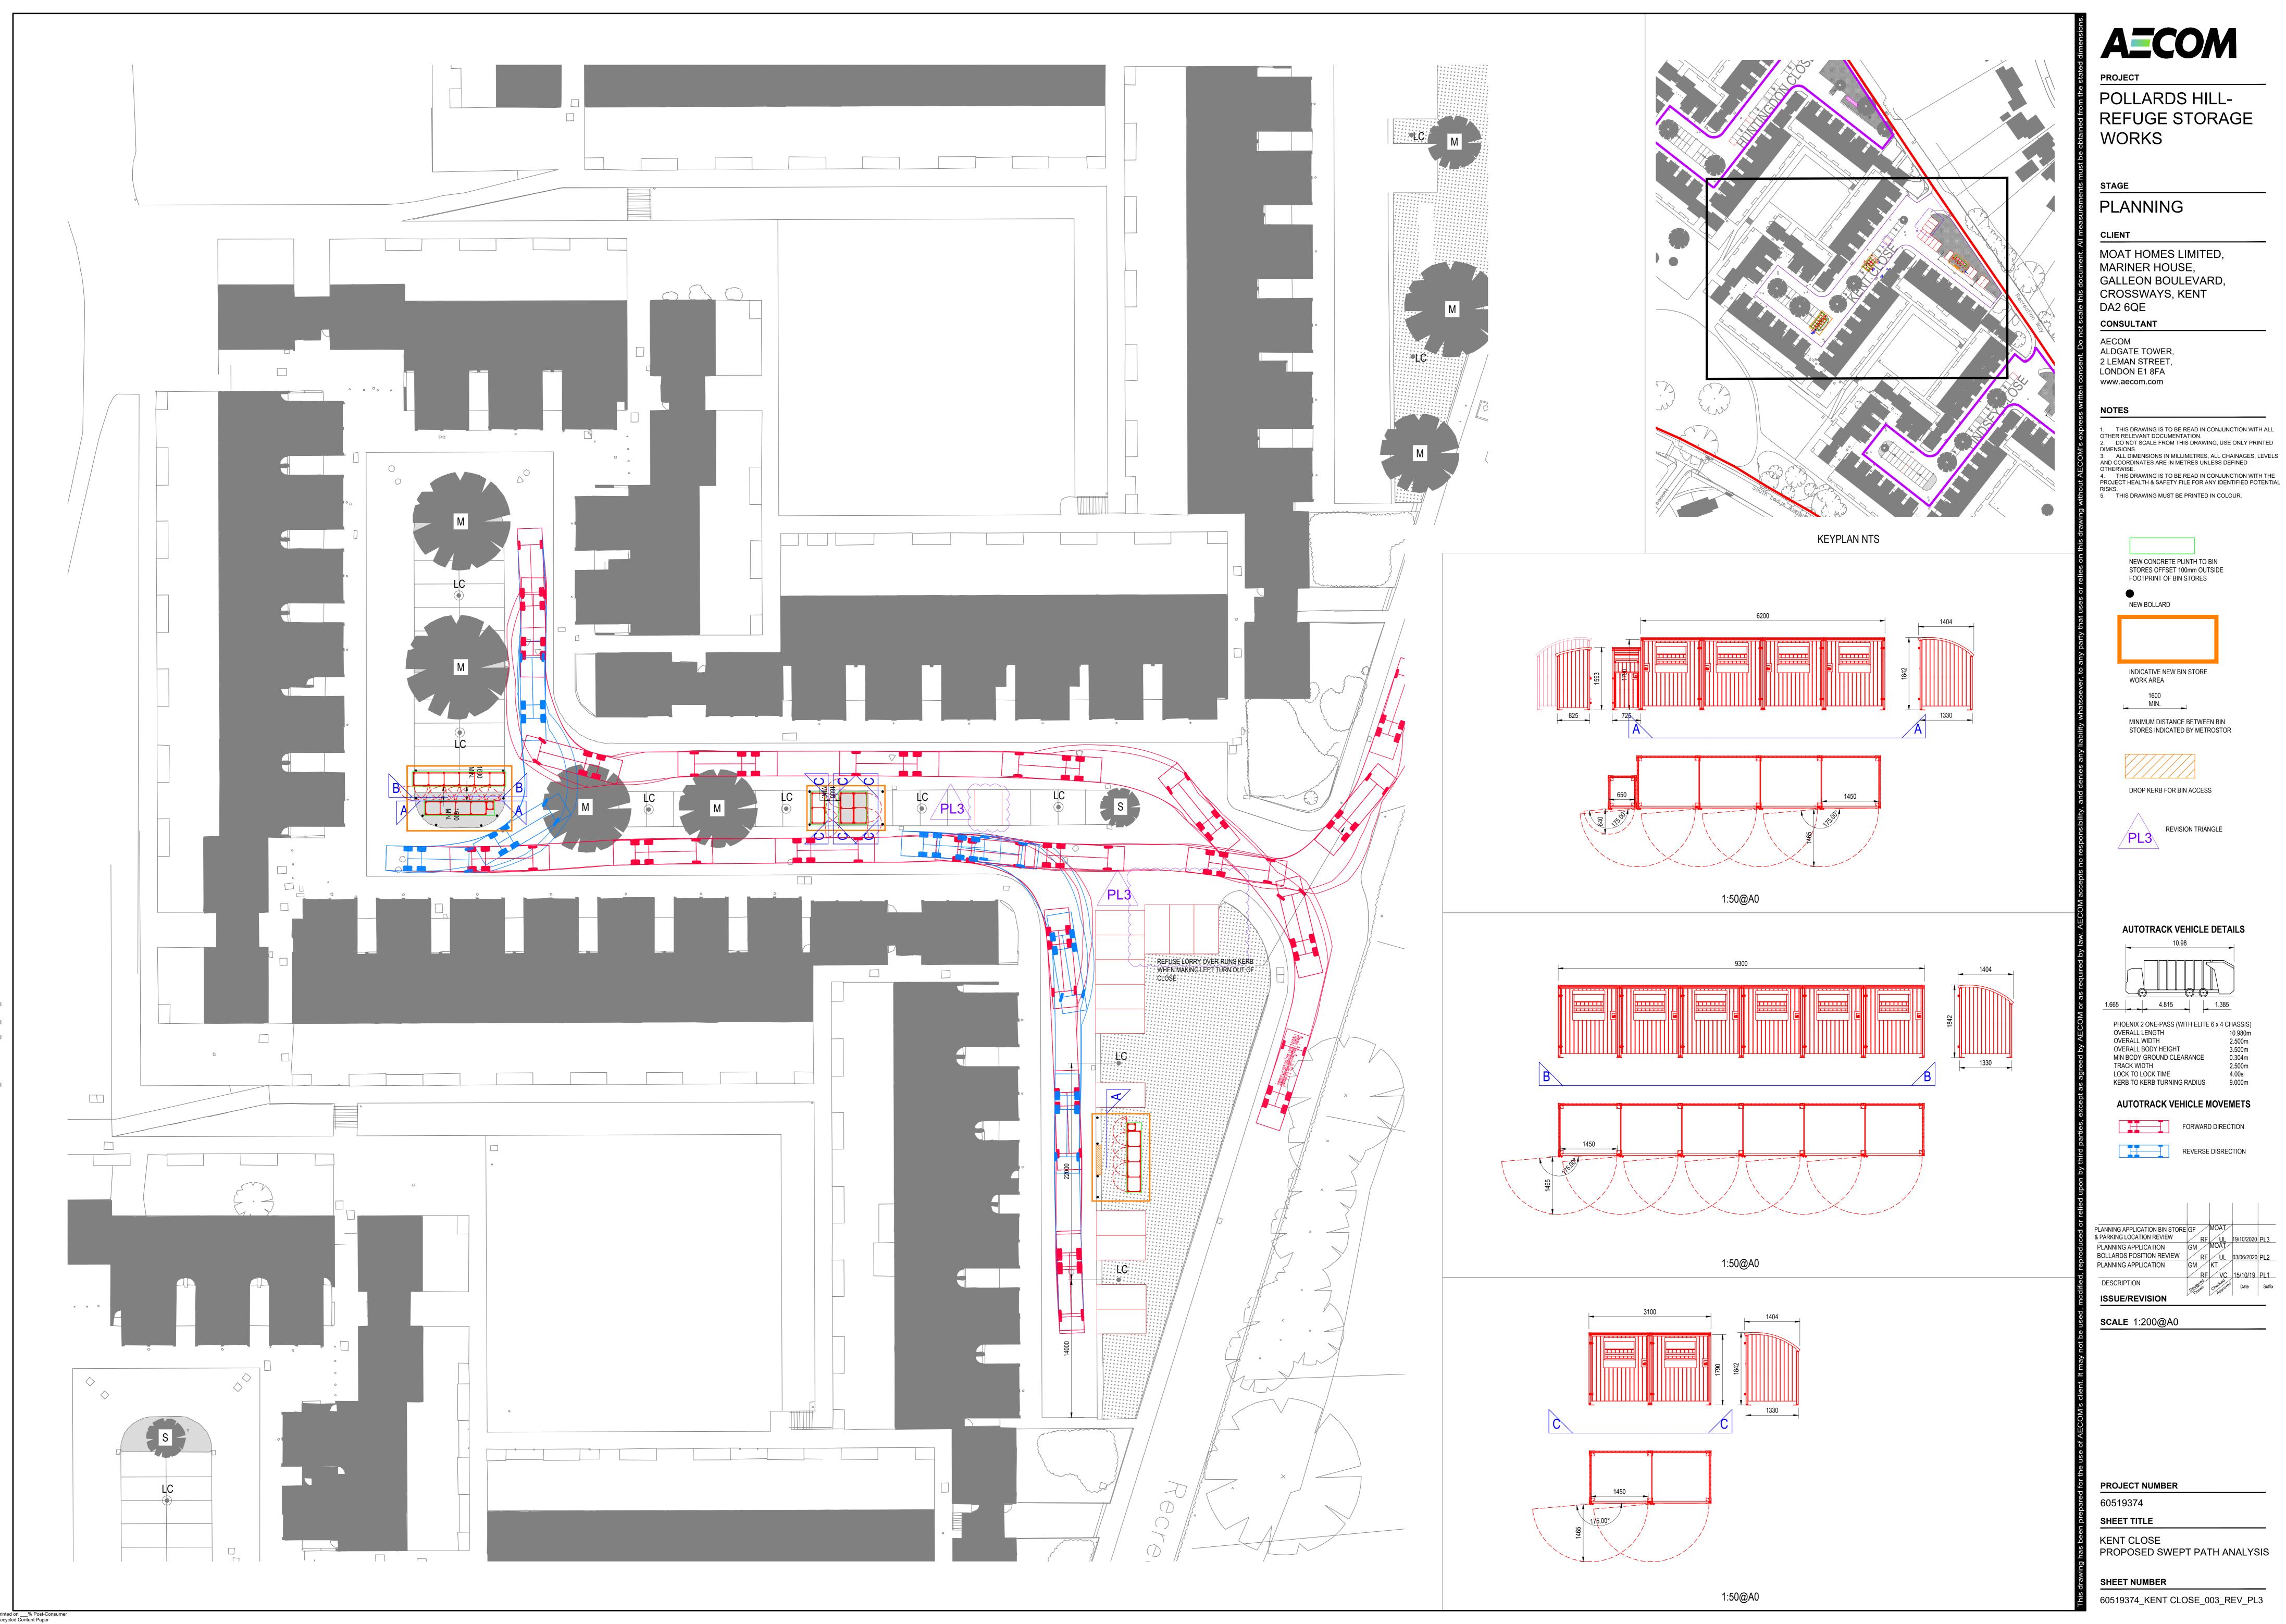

POLLARDS HILL-REFUGE STORAGE

MOAT HOMES LIMITED, MARINER HOUSE, GALLEON BOULEVARD, CROSSWAYS, KENT

ALDGATE TOWER, 2 LEMAN STREET, LONDON E1 8FA

 THIS DRAWING IS TO BE READ IN CONJUNCTION WITH ALL OTHER RELEVANT DOCUMENTATION.
 DO NOT SCALE FROM THIS DRAWING, USE ONLY PRINTED 3. ALL DIMENSIONS IN MILLIMETRES, ALL CHAINAGES, LEVELS
AND COURT OF THE PROPERTY OF THE PROPE

5. THIS DRAWING MUST BE PRINTED IN COLOUR.

NEW CONCRETE PLINTH TO BIN STORES OFFSET 100mm OUTSIDE FOOTPRINT OF BIN STORES

NEW BOLLARD

INDICATIVE NEW BIN STORE

STORES INDICATED BY METROSTOR

DROP KERB FOR BIN ACCESS

REVISION TRIANGLE

AUTOTRACK VEHICLE DETAILS

MIN BODY GROUND CLEARANCE KERB TO KERB TURNING RADIUS 9.000m

AUTOTRACK VEHICLE MOVEMETS

FORWARD DIRECTION REVERSE DISRECTION

& PARKING LOCATION REVIEW

PLANNING APPLICATION


BOLLARDS POSITION REVIEW

PLANNING APPLICATION

SCALE 1:200@A0

PROPOSED SWEPT PATH ANALYSIS

60519374_KENT CLOSE_003_REV_PL3

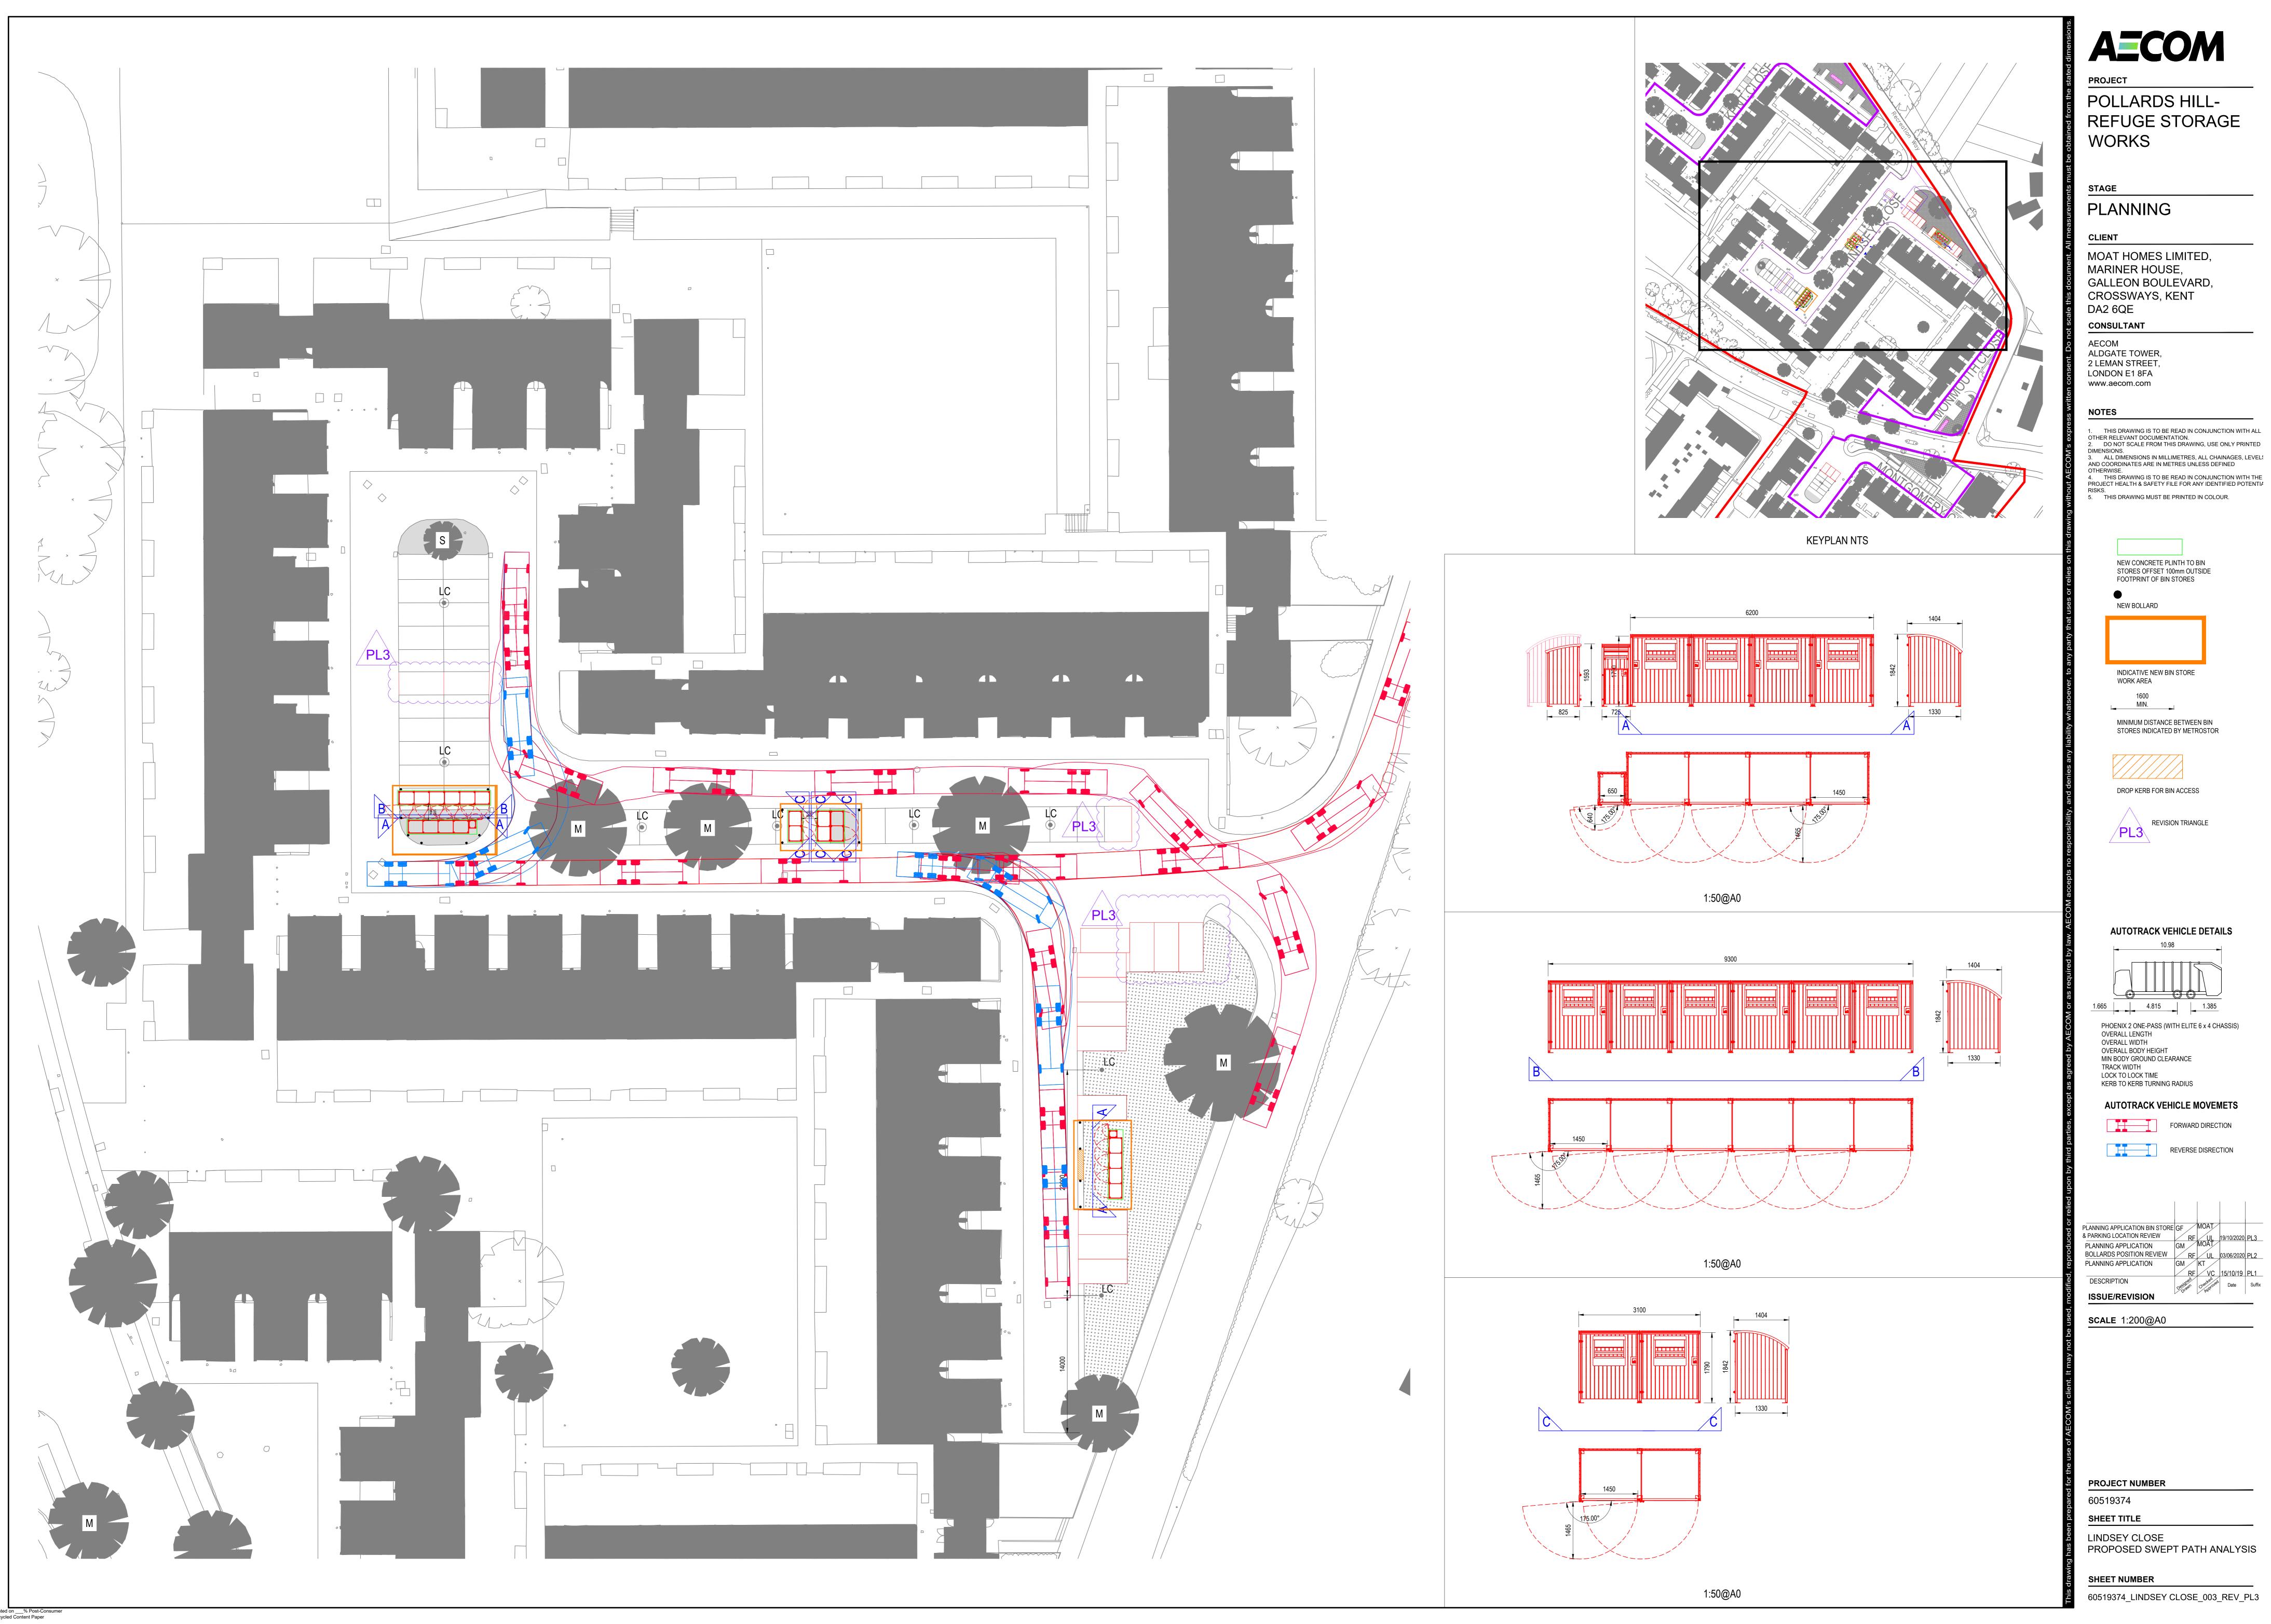

POLLARDS HILL-REFUGE STORAGE WORKS

PLANNING

MOAT HOMES LIMITED, MARINER HOUSE, GALLEON BOULEVARD, CROSSWAYS, KENT

ALDGATE TOWER, 2 LEMAN STREET, LONDON E1 8FA

 THIS DRAWING IS TO BE READ IN CONJUNCTION WITH ALL OTHER RELEVANT DOCUMENTATION.
 DO NOT SCALE FROM THIS DRAWING, USE ONLY PRINTED 3. ALL DIMENSIONS IN MILLIMETRES, ALL CHAINAGES, LEVELS
AND COORDINATES ARE IN METRES UNLESS DEFINED

5. THIS DRAWING MUST BE PRINTED IN COLOUR.

NEW CONCRETE PLINTH TO BIN STORES OFFSET 100mm OUTSIDE FOOTPRINT OF BIN STORES

NEW BOLLARD

INDICATIVE NEW BIN STORE WORK AREA

MINIMUM DISTANCE BETWEEN BIN STORES INDICATED BY METROSTOR

DROP KERB FOR BIN ACCESS

REVISION TRIANGLE

AUTOTRACK VEHICLE DETAILS

PHOENIX 2 ONE-PASS (WITH ELITE 6 x 4 CHASSIS)

OVERALL LENGTH OVERALL WIDTH OVERALL BODY HEIGHT MIN BODY GROUND CLEARANCE LOCK TO LOCK TIME

KERB TO KERB TURNING RADIUS AUTOTRACK VEHICLE MOVEMETS

FORWARD DIRECTION REVERSE DISRECTION

PLANNING APPLICATION BIN STORE GF MOAT & PARKING LOCATION REVIEW PLANNING APPLICATION
BOLLARDS POSITION REVIEW

PLANNING APPLICATION


ISSUE/REVISION

SCALE 1:200@A0


PROJECT NUMBER

SHEET TITLE

SHEET NUMBER 60519374_LINDSEY CLOSE_003_REV_PL3

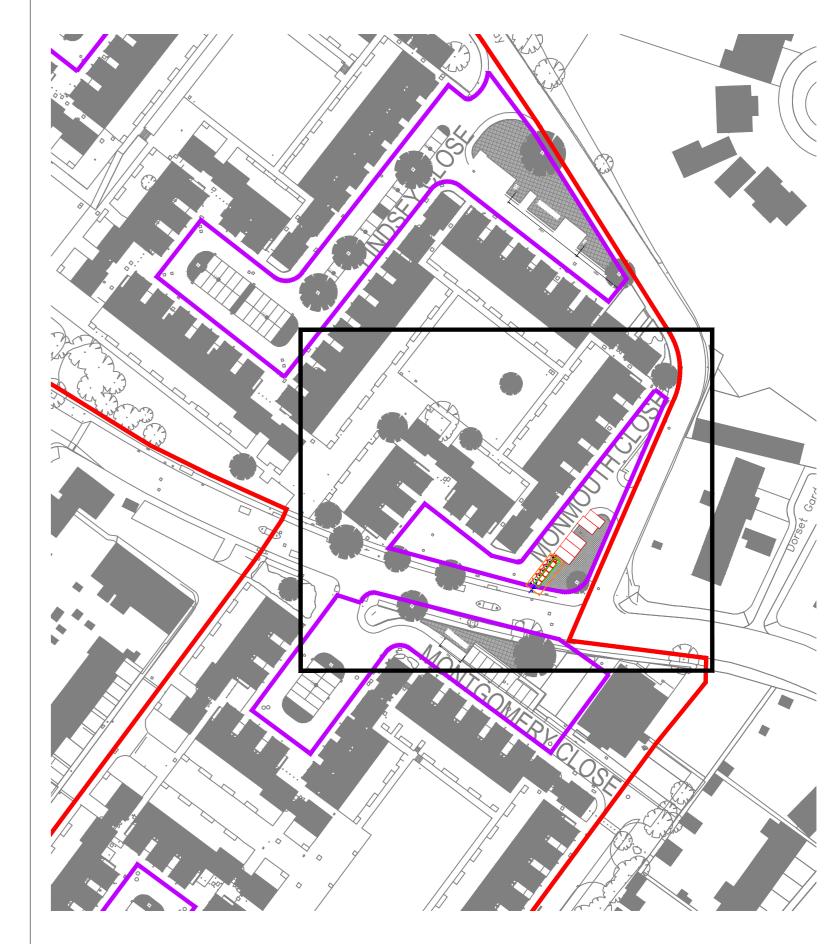

KEYPLAN NTS

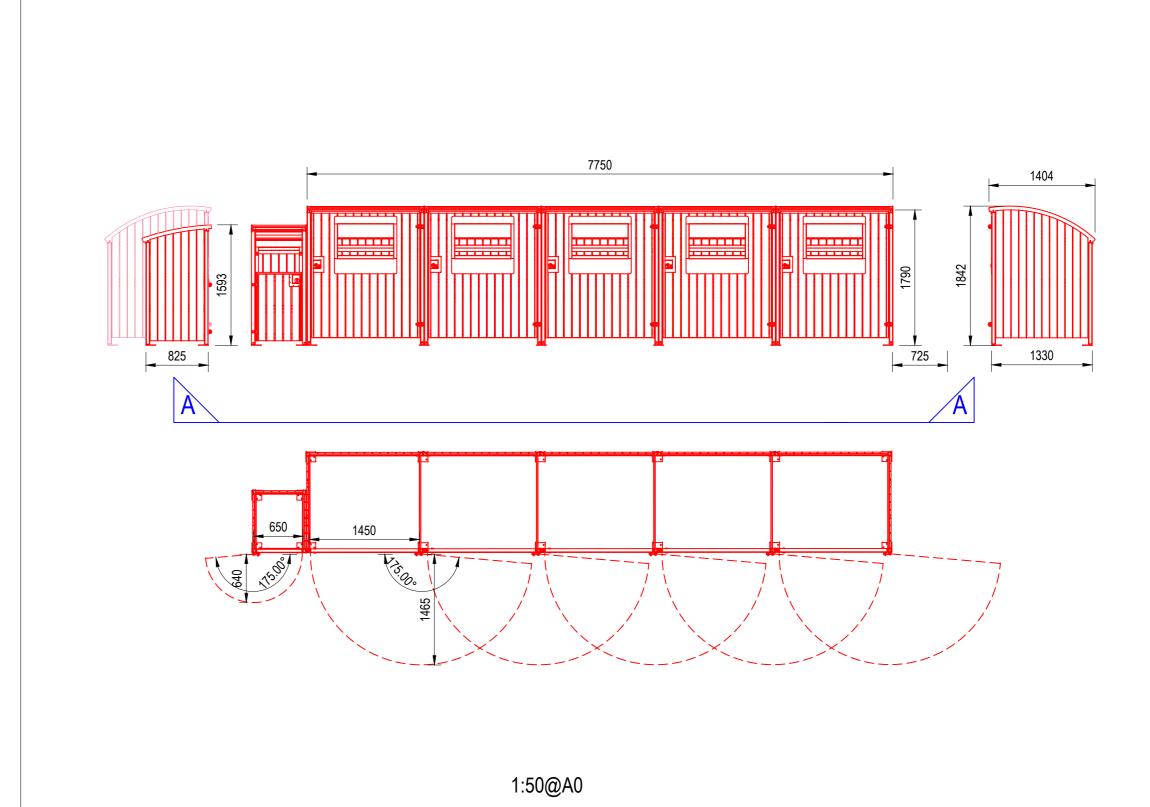

POLLARDS HILL-REFUGE STORAGE WORKS

PLANNING


MOAT HOMES LIMITED, MARINER HOUSE, GALLEON BOULEVARD, CROSSWAYS, KENT DA2 6QE

AECOM ALDGATE TOWER, 2 LEMAN STREET, LONDON E1 8FA www.aecom.com

CONSULTANT

1. THIS DRAWING IS TO BE READ IN CONJUNCTION WITH ALL OTHER RELEVANT DOCUMENTATION.
2. DO NOT SCALE FROM THIS DRAWING, USE ONLY PRINTED 3. ALL DIMENSIONS IN MILLIMETRES, ALL CHAINAGES, LEVELS
AND COORDINATES ARE IN METRES UNLESS DEFINED 4. THIS DRAWING IS TO BE READ IN CONJUNCTION WITH THE PROJECT HEALTH & SAFETY FILE FOR ANY IDENTIFIED POTENTIF

5. THIS DRAWING MUST BE PRINTED IN COLOUR.

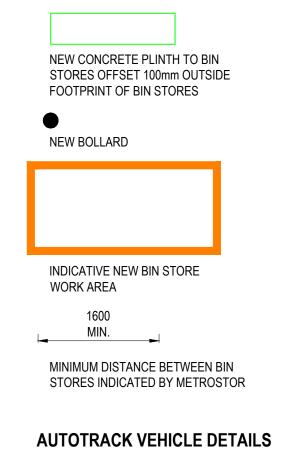


PHOENIX 2 ONE-PASS (WITH ELITE 6 x 4 CHASSIS)
OVERALL LENGTH 10.980m
OVERALL WIDTH 2.500m
OVERALL BODY HEIGHT 3.500m
MIN BODY GROUND CLEARANCE 0.304m
TRACK WIDTH 2.500m
LOCK TO LOCK TIME 4.00s
KERB TO KERB TURNING RADIUS 9.000m

AUTOTRACK VEHICLE MOVEMETS

FORWARD DIRECTION

REVERSE DISRECTION

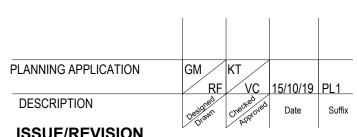

ISSUE/REVISION

SCALE 1:200@A0

PROJECT NUMBER

SHEET TITLE

MONMOUTH CLOSE PROPOSED SWEPT PATH ANALYSIS

SHEET NUMBER

60519374_MONMOUTH CLOSE_003_REV_PL1

PROJECT

POLLARDS HILL-REFUGE STORAGE WORKS

STAG

PLANNING

CLIENT

MOAT HOMES LIMITED, MARINER HOUSE, GALLEON BOULEVARD, CROSSWAYS, KENT DA2 6QE

AECOM ALDGATE TOWER, 2 LEMAN STREET, LONDON E1 8FA

NOTES

CONSULTANT

www.aecom.com

1. THIS DRAWING IS TO BE READ IN CONJUNCTION WITH ALL OTHER RELEVANT DOCUMENTATION.
2. DO NOT SCALE FROM THIS DRAWING, USE ONLY PRINTED DIMENSIONS.
3. ALL DIMENSIONS IN MILLIMETRES, ALL CHAINAGES, LEVELS AND COORDINATES ARE IN METRES UNLESS DEFINED.

4. THIS DRAWING IS TO BE READ IN CONJUNCTION WITH THE PROJECT HEALTH & SAFETY FILE FOR ANY IDENTIFIED POTENTIF

5. THIS DRAWING MUST BE PRINTED IN COLOUR.

NEW CONCRETE PLINTH TO BIN STORES OFFSET 100mm OUTSIDE FOOTPRINT OF BIN STORES

NEW BOLLARD

INDICATIVE NEW BIN STORE WORK AREA

MINIMUM DISTANCE BETWEEN BIN STORES INDICATED BY METROSTOR

DROP KERB FOR BIN ACCESS

REVISION TRIANGLE

AUTOTRACK VEHICLE DETAILS

1.665 4.815 1.385

PHOENIX 2 ONE-PASS (WITH ELITE 6 x 4 OVERALL LENGTH OVERALL WIDTH OVERALL BODY HEIGHT MIN BODY GROUND CLEARANCE TRACK WIDTH

MIN BODY GROUND CLEARANCE
TRACK WIDTH
LOCK TO LOCK TIME
KERB TO KERB TURNING RADIUS

AUTOTRACK VEHICLE MOVEMETS

FORWARD DIRECTION

REVERSE DISRECTION

PLANNING APPLICATION BIN STORE GF
& PARKING LOCATION REVIEW
PLANNING APPLICATION
BOLLARDS POSITION REVIEW
PLANNING APPLICATION
BOLLARDS POSITION REVIEW
PLANNING APPLICATION
BOLLARDS POSITION REVIEW
PLANNING APPLICATION
BE VC 15/10/19 PL1

DESCRIPTION
ISSUE/REVISION

SCALE 1:200@A0

PROJECT NUMBER


60519374 **SHEET TITLE**

MONTGOMERY CLOSE PROPOSED SWEPT PATH ANALYSIS

SHEET NUMBER

SHEET NUMBER

60519374_MONTGOMERY CLOSE_003_REV_PL3

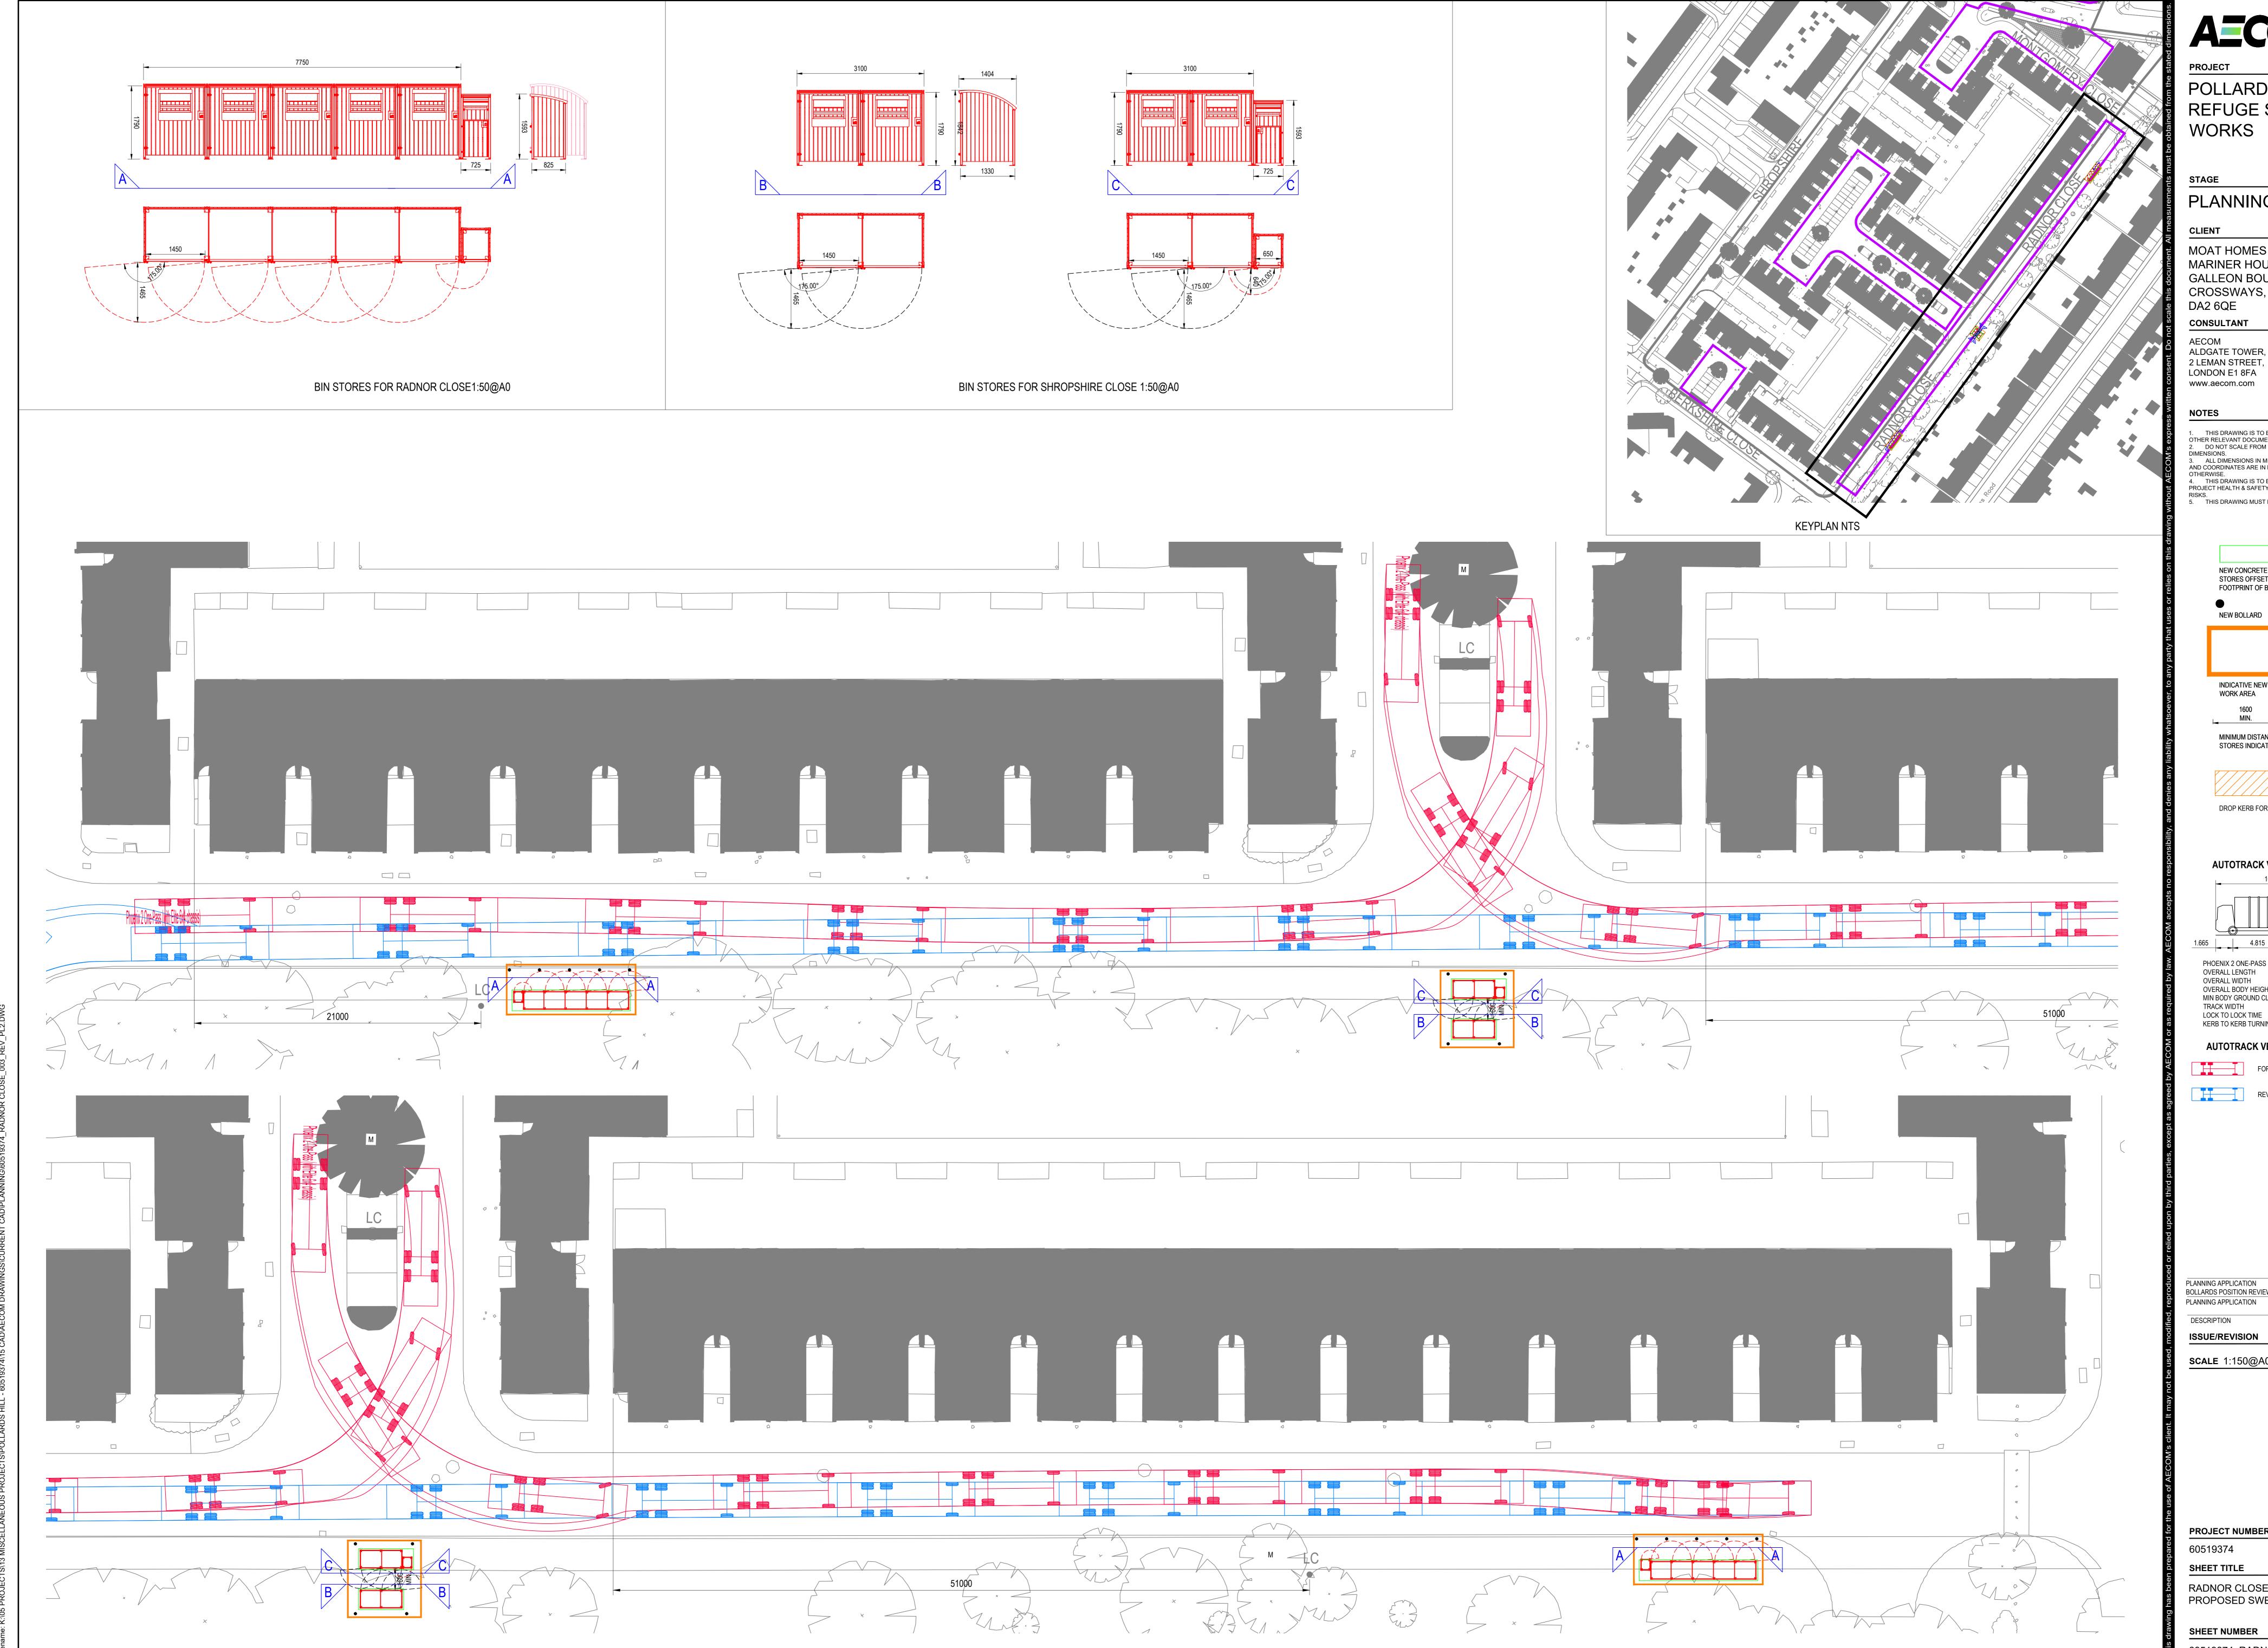

POLLARDS HILL-REFUGE STORAGE WORKS

MOAT HOMES LIMITED, MARINER HOUSE, GALLEON BOULEVARD, CROSSWAYS, KENT

CONSULTANT

ALDGATE TOWER, 2 LEMAN STREET, LONDON E1 8FA www.aecom.com

1. THIS DRAWING IS TO BE READ IN CONJUNCTION WITH ALL OTHER RELEVANT DOCUMENTATION. DO NOT SCALE FROM THIS DRAWING, USE ONLY PRINTED 3. ALL DIMENSIONS IN MILLIMETRES, ALL CHAINAGES, LEVELS AND COORDINATES ARE IN METRES UNLESS DEFINED

4. THIS DRAWING IS TO BE READ IN CONJUNCTION WITH THE PROJECT HEALTH & SAFETY FILE FOR ANY IDENTIFIED POTENTIAL 5. THIS DRAWING MUST BE PRINTED IN COLOUR.

> NEW CONCRETE PLINTH TO BIN STORES OFFSET 100mm OUTSIDE FOOTPRINT OF BIN STORES

INDICATIVE NEW BIN STORE

STORES INDICATED BY METROSTOR

DROP KERB FOR BIN ACCESS

AUTOTRACK VEHICLE DETAILS

OVERALL BODY HEIGHT MIN BODY GROUND CLEARANCE

KERB TO KERB TURNING RADIUS

AUTOTRACK VEHICLE MOVEMETS

FORWARD DIRECTION

REVERSE DISRECTION

BOLLARDS POSITION REVIEW

ISSUE/REVISION

SCALE 1:150@A0


PROJECT NUMBER

SHEET TITLE

RADNOR CLOSE PROPOSED SWEPT PATH ANALYSIS

SHEET NUMBER

60519374_RADNOR CLOSE_003_REV_PL2

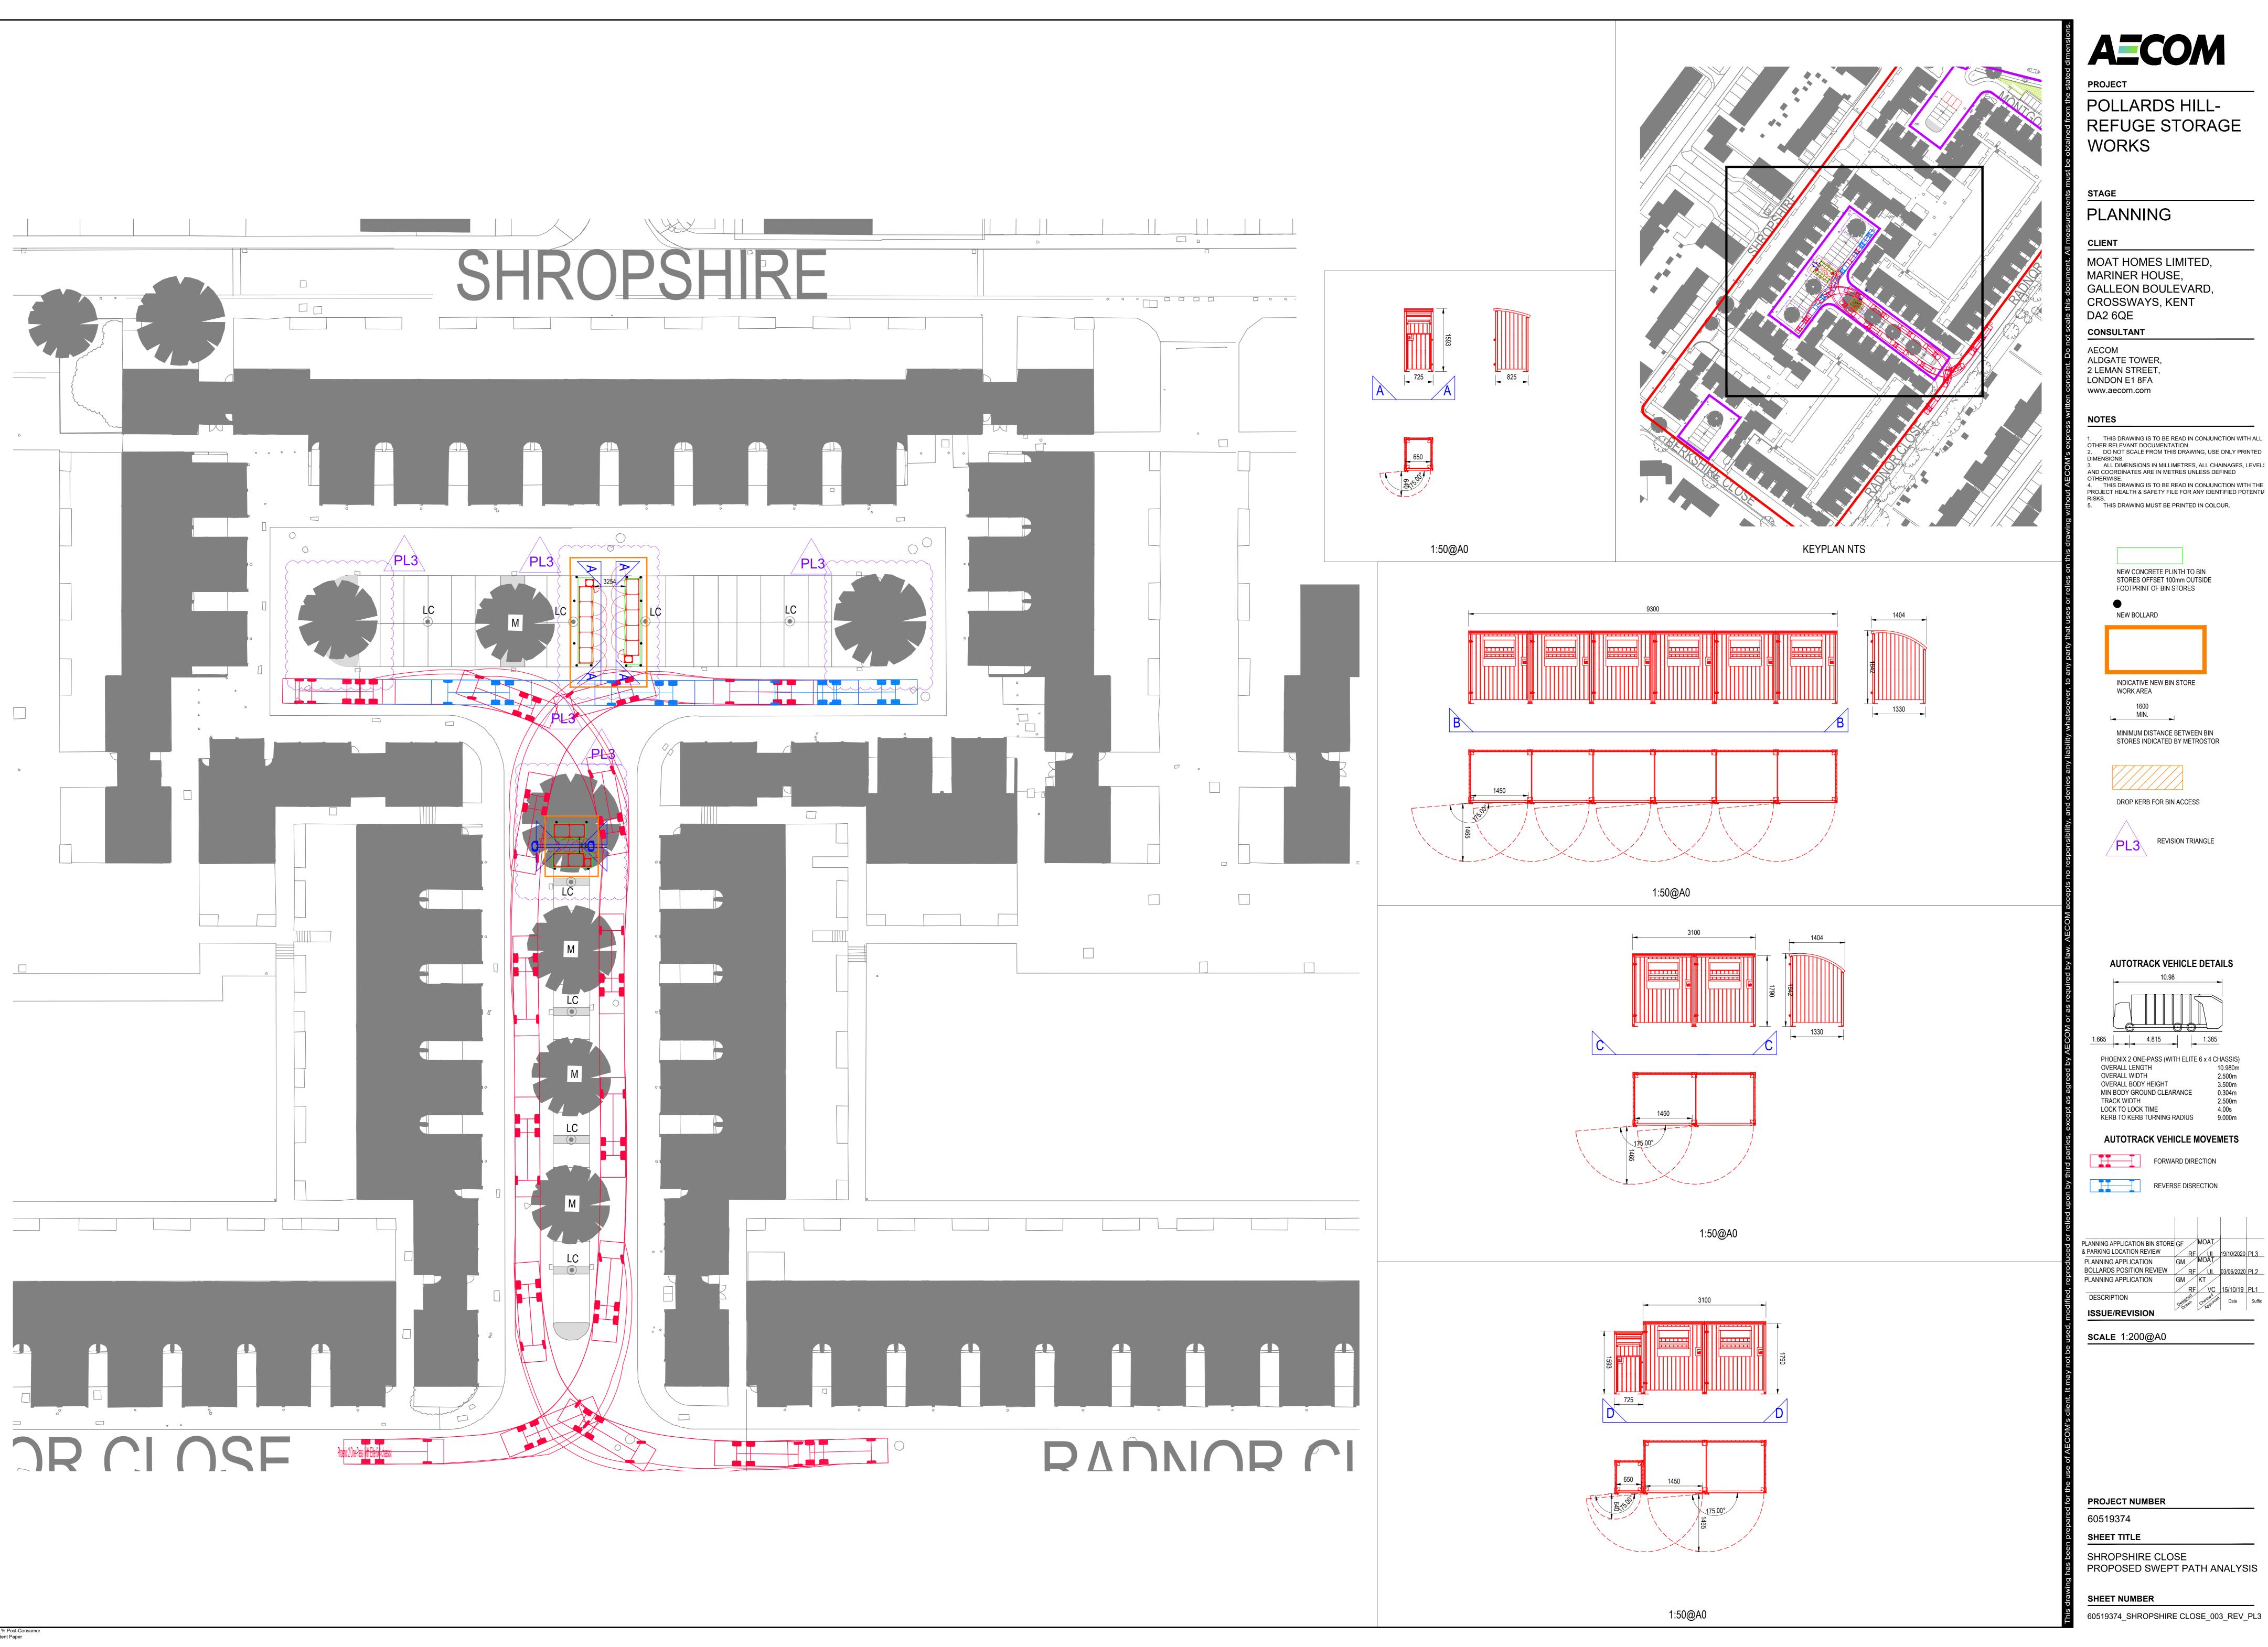

POLLARDS HILL-REFUGE STORAGE WORKS

MOAT HOMES LIMITED, MARINER HOUSE, GALLEON BOULEVARD, CROSSWAYS, KENT

ALDGATE TOWER, 2 LEMAN STREET,

1. THIS DRAWING IS TO BE READ IN CONJUNCTION WITH ALL OTHER RELEVANT DOCUMENTATION. . DO NOT SCALE FROM THIS DRAWING, USE ONLY PRINTED 3. ALL DIMENSIONS IN MILLIMETRES, ALL CHAINAGES, LEVELS AND COORDINATES ARE IN METRES UNLESS DEFINED 4. THIS DRAWING IS TO BE READ IN CONJUNCTION WITH THE

> NEW CONCRETE PLINTH TO BIN STORES OFFSET 100mm OUTSIDE FOOTPRINT OF BIN STORES

> INDICATIVE NEW BIN STORE **WORK AREA**

MINIMUM DISTANCE BETWEEN BIN STORES INDICATED BY METROSTOR

DROP KERB FOR BIN ACCESS

AUTOTRACK VEHICLE DETAILS

OVERALL BODY HEIGHT MIN BODY GROUND CLEARANCE

LOCK TO LOCK TIME KERB TO KERB TURNING RADIUS

AUTOTRACK VEHICLE MOVEMETS

PLANNING APPLICATION BIN STORE GF MOAT PLANNING APPLICATION BOLLARDS POSITION REVIEW PLANNING APPLICATION

SCALE 1:200@A0

PROJECT NUMBER

SHEET TITLE

SHEET NUMBER

60519374_SHROPSHIRE CLOSE_003_REV_PL3

nMoathomes

Date: 05 September 2019

Quotation Ref:

15028

Project Contact:

Alan Mortimer





nMoathomes

Date: 05 September 2019

Quotation Ref:

15028


Project Contact:

Alan Mortimer






NORTHGATE SE GIS Print Template

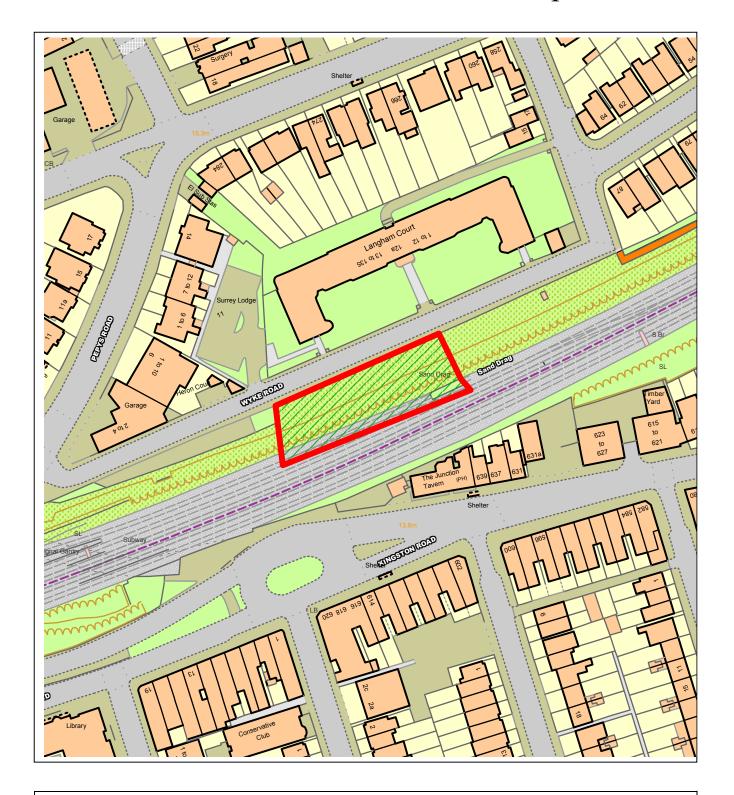

This material has been reproduced from Ordnance Survey digital map data with the permission of the controller of Her Majesty's Stationery Office, © Crown Copyright.



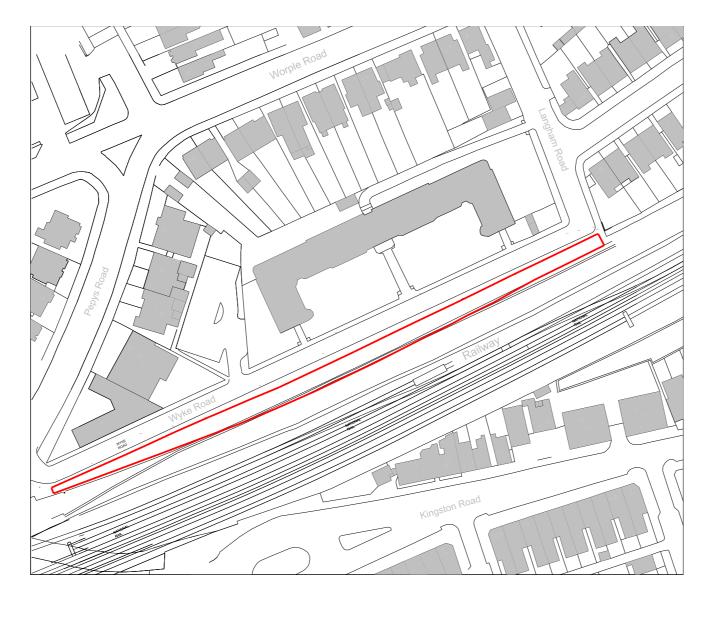

E 24.02.20 For Planning AD TR
D 21.02.20 For Planning AD TR
C 19.02.20 For Planning AD TR
B 18.02.20 For Planning AD TR
A 15.10.19 For Info TR
NN

rev date notes drawn by checked by
1: Originator 2: Project Architect 3: Director D

PLANNING ISSUE

PLANNING ISSUE

16 Mandeville Courtyard, 142 Battersea Park Road, London SW11 telt +44 (0) 20 7720 5999

client Hugo Fonseca

project Wyke Road

drawing title

Location Plan

project start date September 2019 / 1:1250 @ A3


drawing number September 2019 / 1:1250 @ A3


drawing number E


507 PL(0)0001

Scale in Meters

0 25 50 75

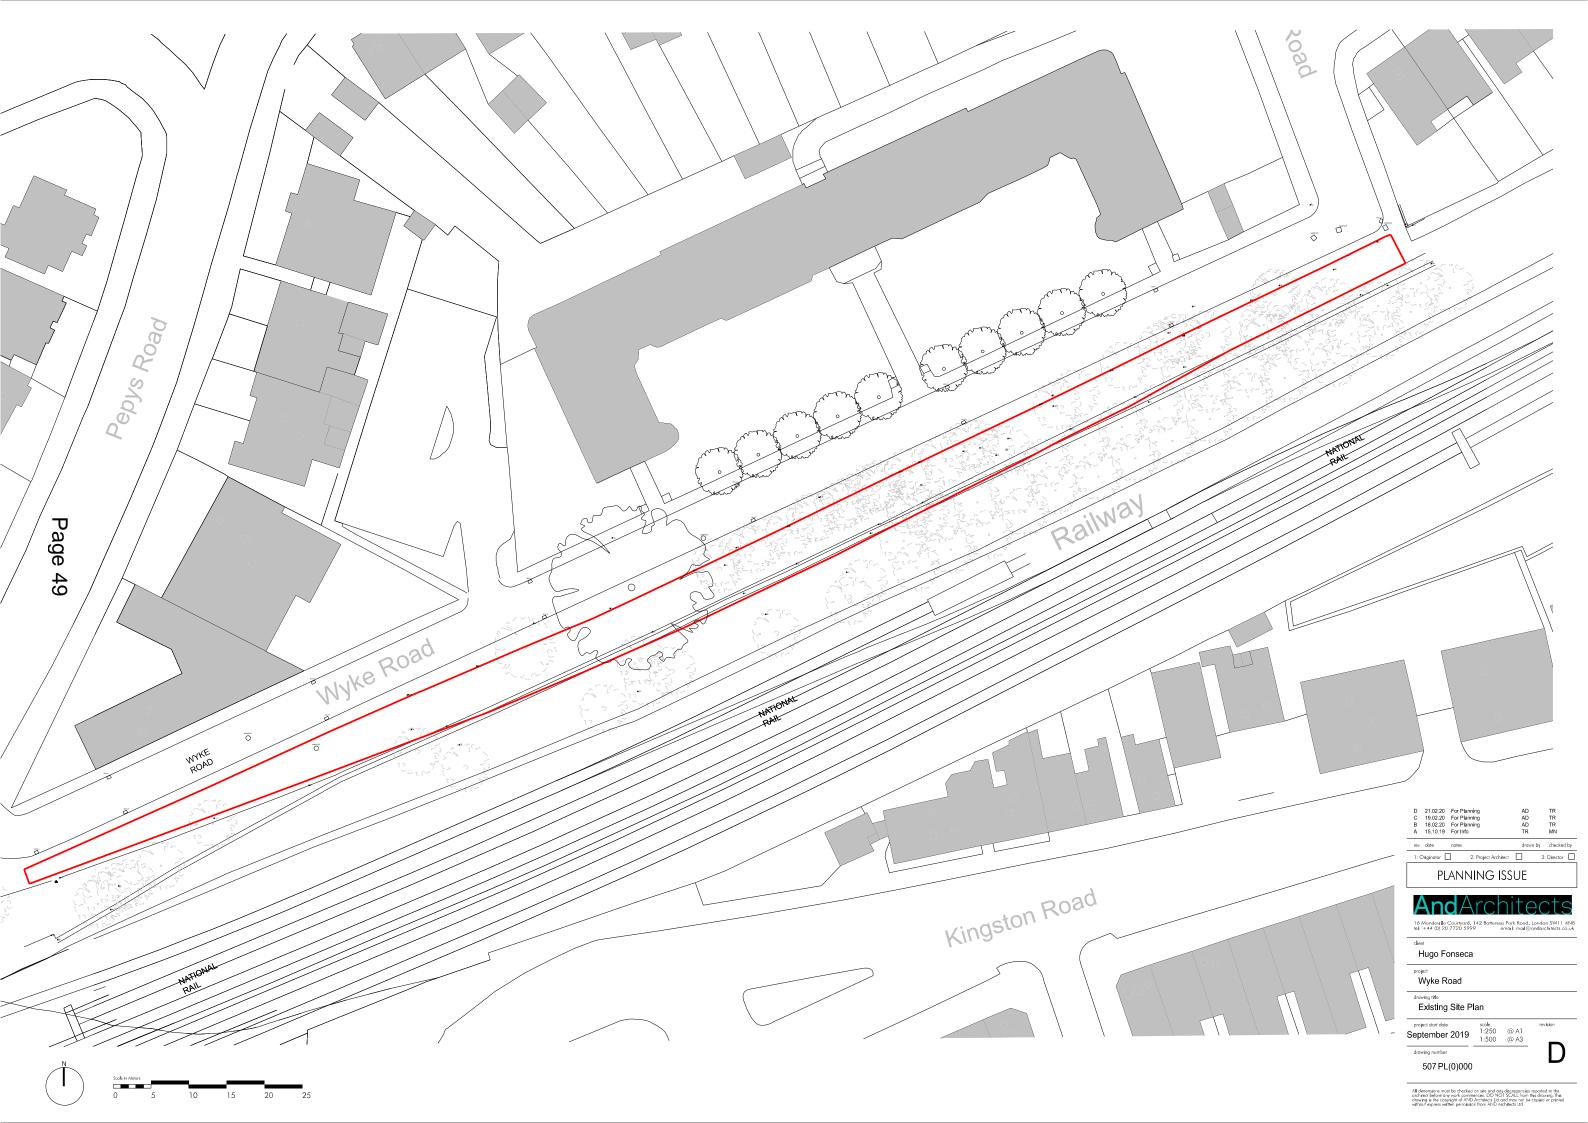


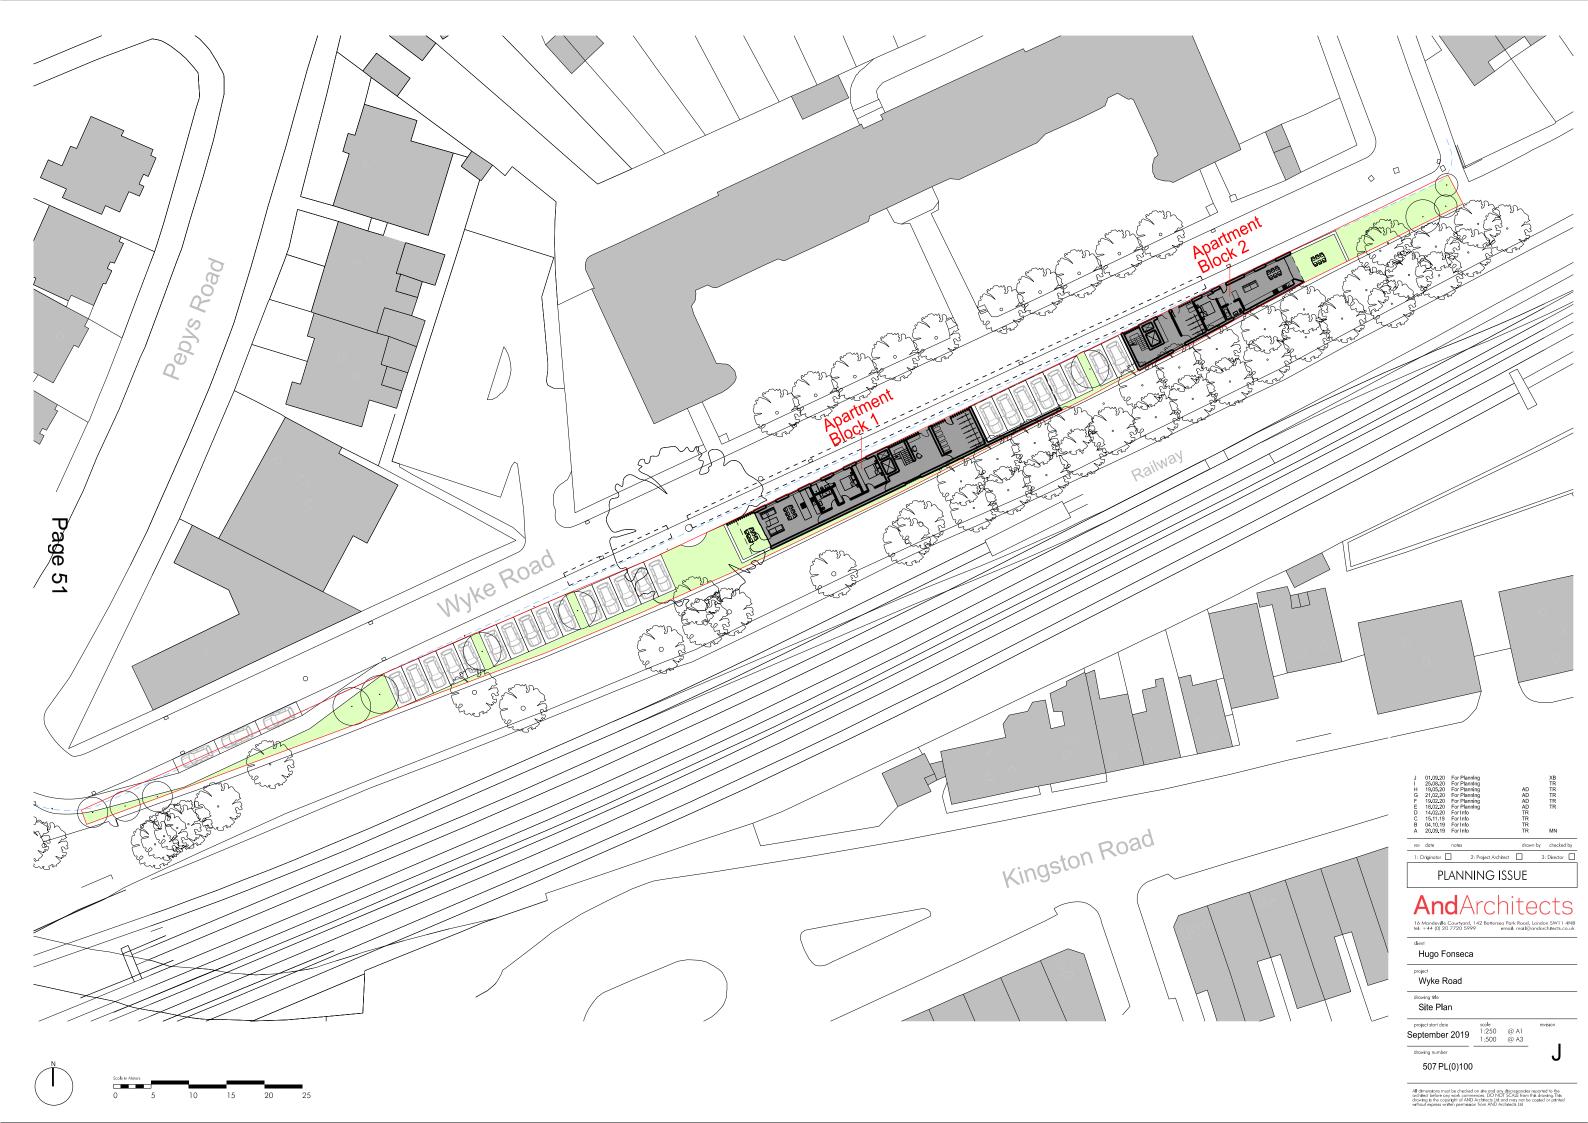

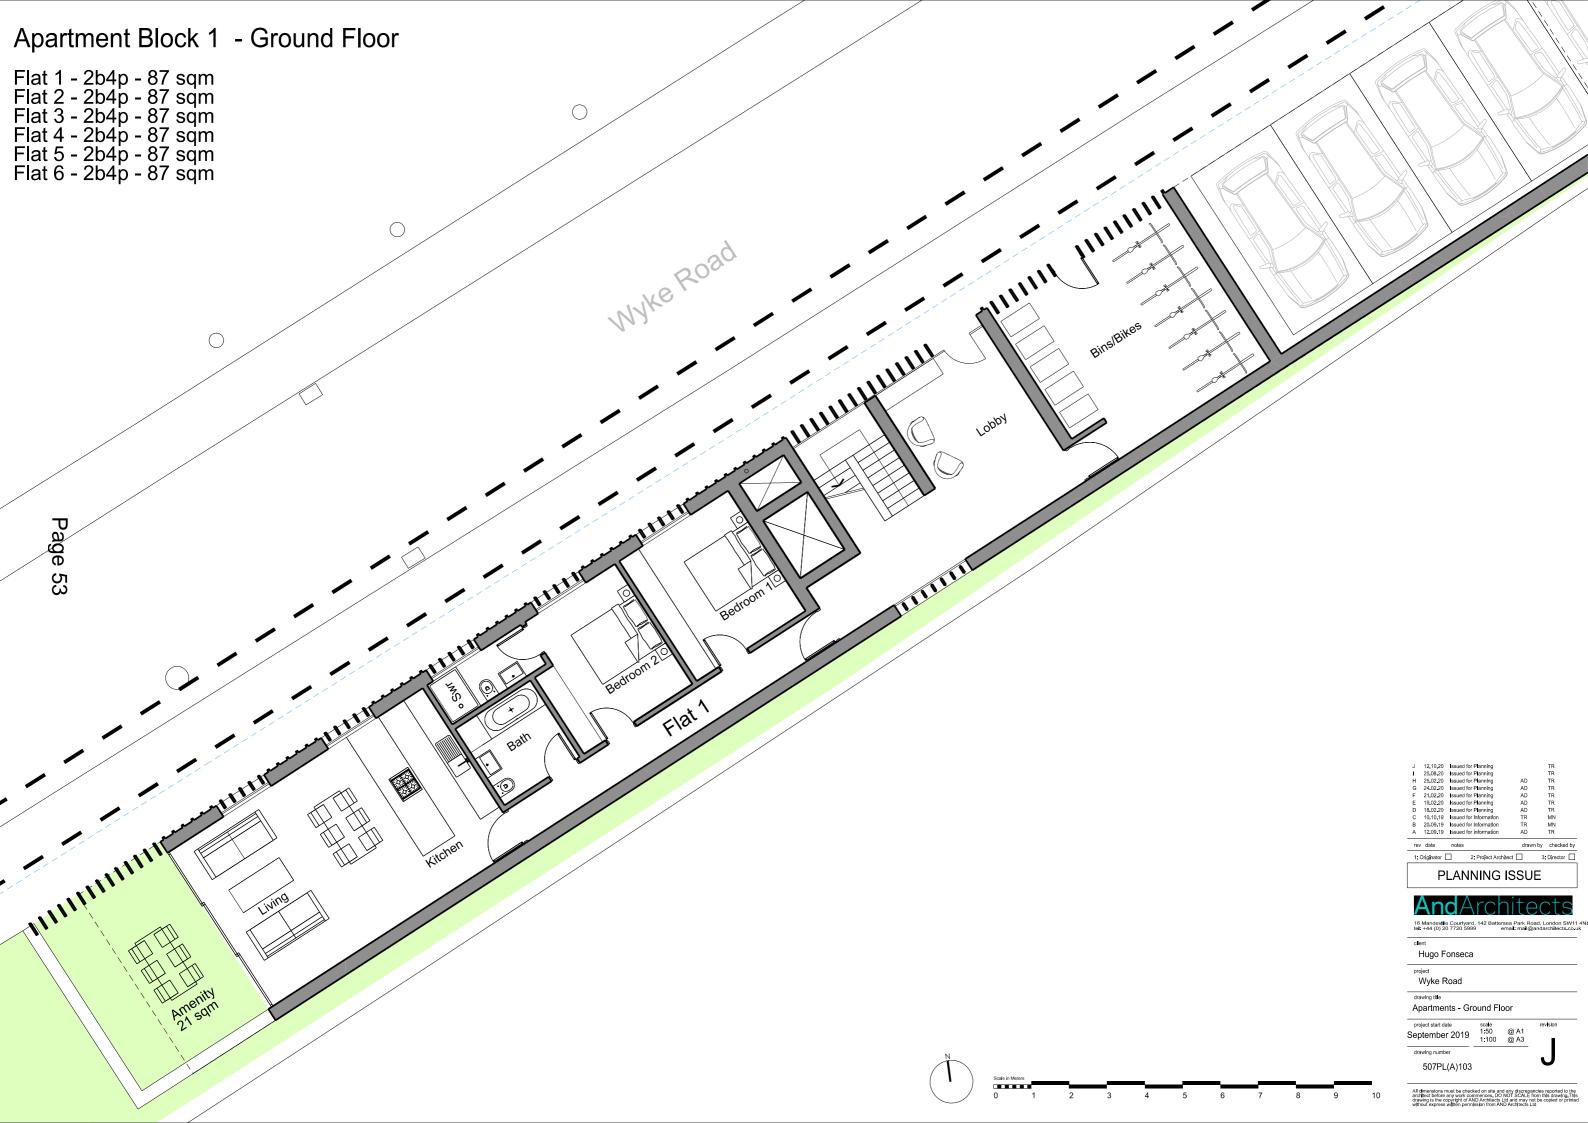


Apartment Block 2 - Ground Floor


Flat 7 - 1b2p - 53 sqm Flat 8 - 2b4p - 73 sqm Flat 9 - 3b6p - 140sqm

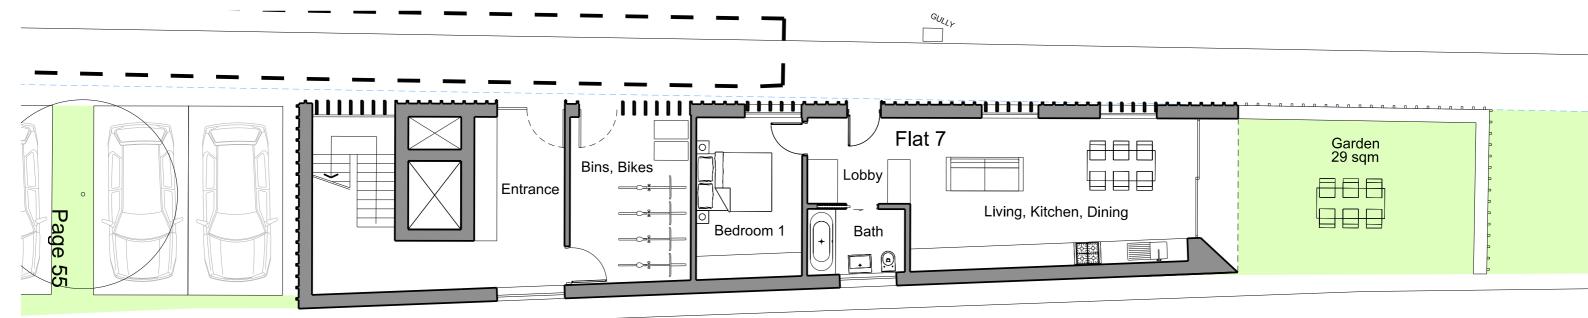




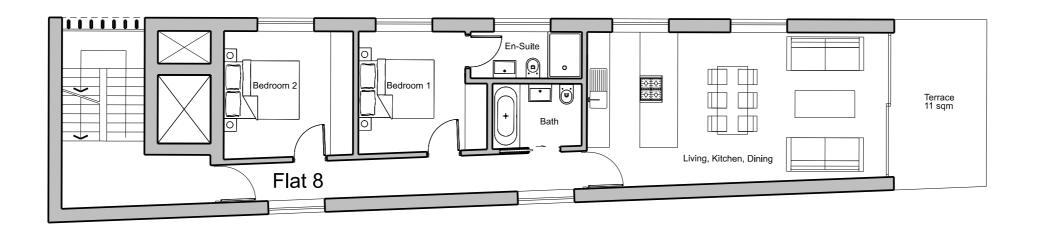


FOR INFORMATION ONLY clent Hugo Fonseca project Wyke Road drawing title Apartment Block 2 First Floor 507 PL(H)104

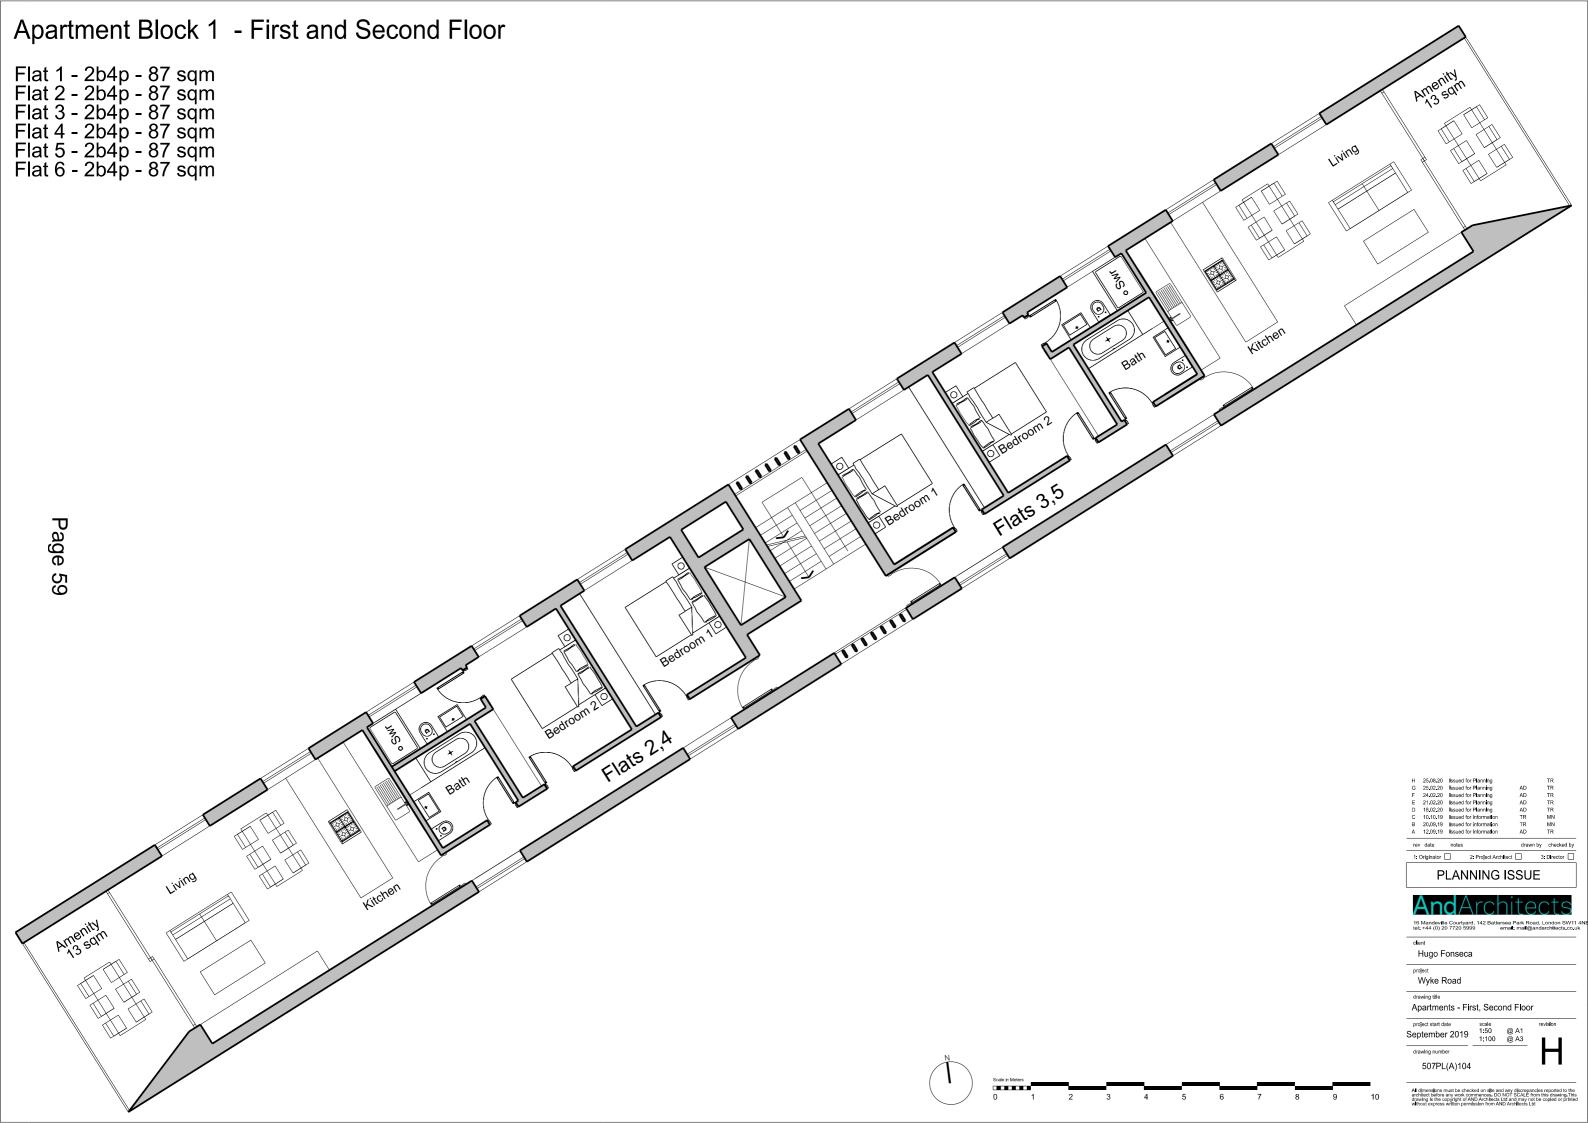



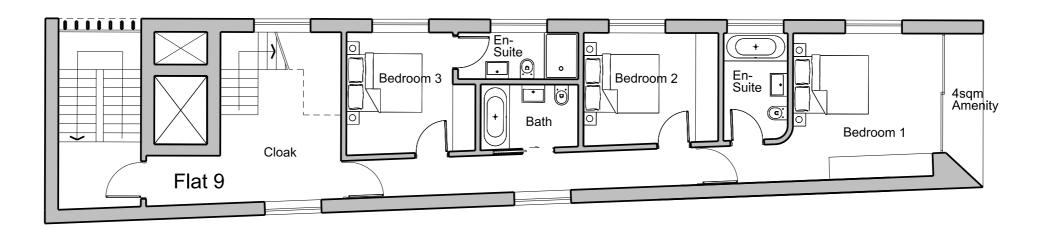




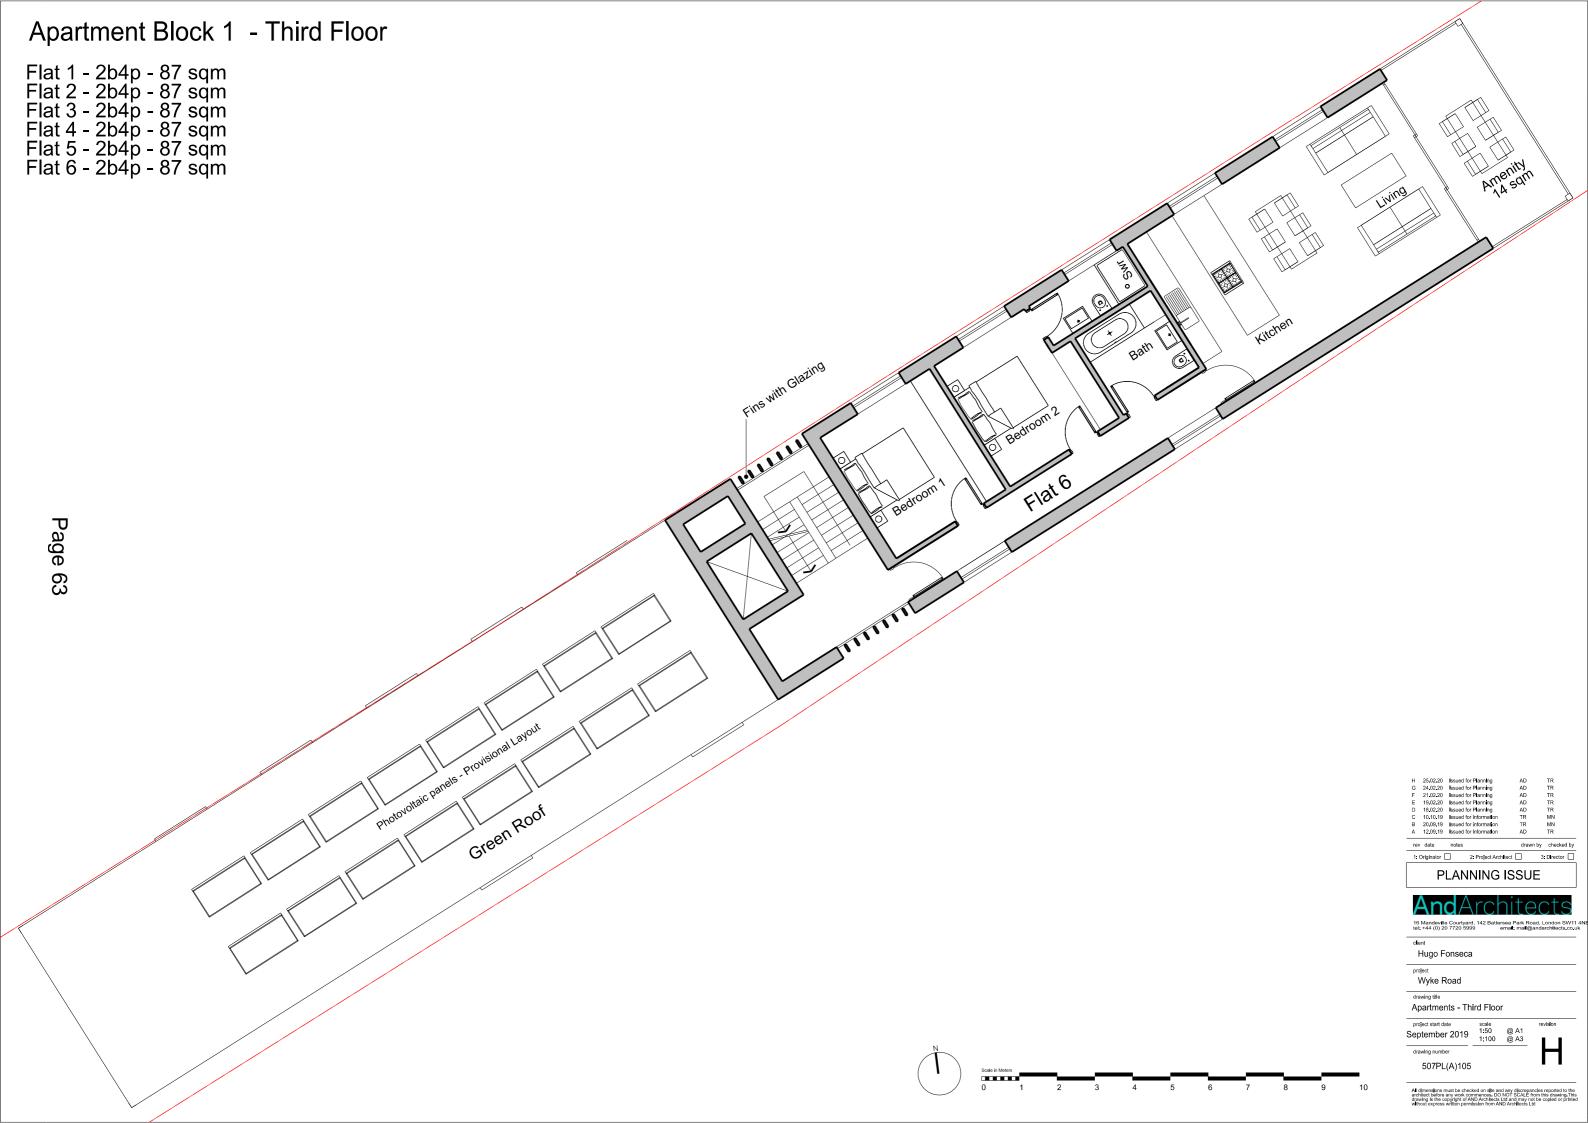


Apartment Block 2 - Third Floor

Flat 7 - 1b2p - 53 sqm Flat 8 - 2b4p - 73 sqm Flat 9 - 3b6p - 140sqm

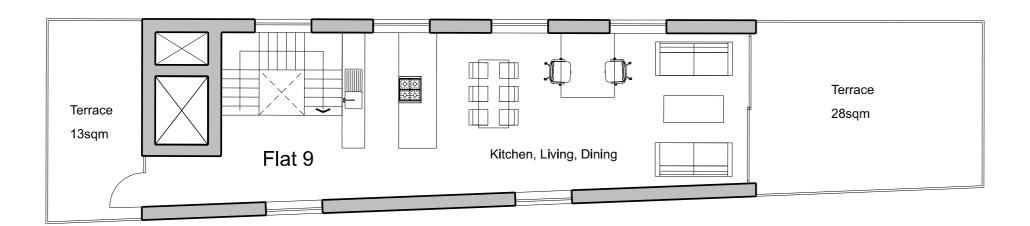

Page 65

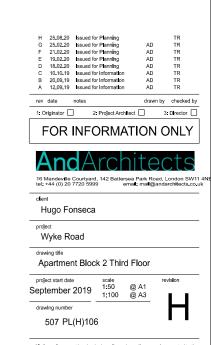






Apartment Block 1 - Roof Plan

Flat 1 - 2b4p - 87 sqm Flat 2 - 2b4p - 87 sqm Flat 3 - 2b4p - 87 sqm Flat 4 - 2b4p - 87 sqm Flat 5 - 2b4p - 87 sqm Flat 6 - 2b4p - 87 sqm

Page 67

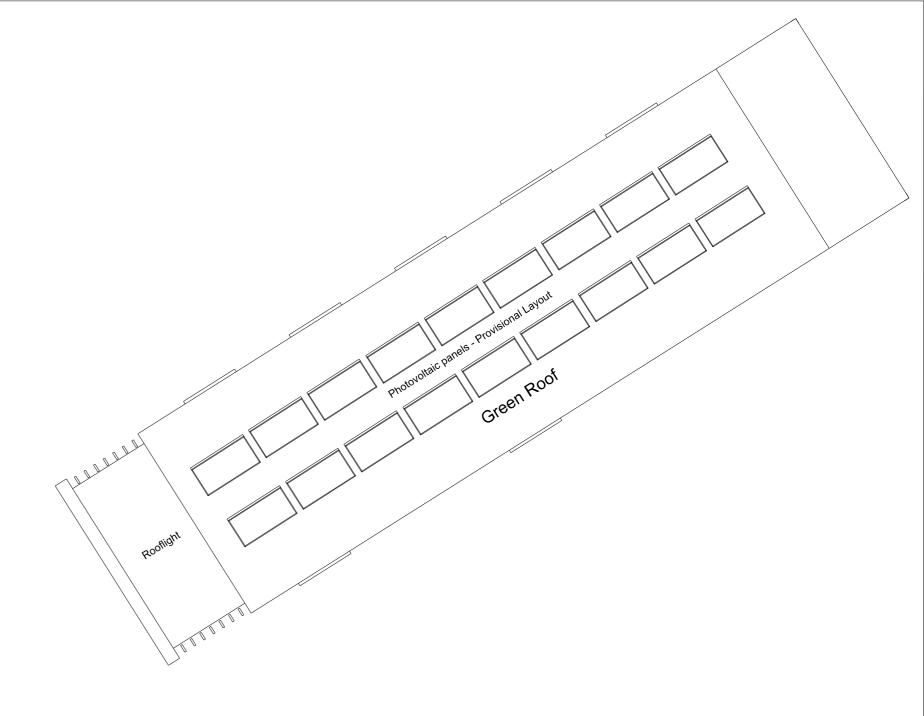



rev date notes drawn by checked by

1: Originator 2: Project Architect 3: Director

rawing number 507PL(A)106

All dimensions must be checked on site and any discrepancies reported tarchitect before any work commences. DO NOT SCALE from this drawing

Scale in Meters

0 1 2 3 4 5 6 7 8 9 10

Apartment Block 2 - Roof Plan

Flat 7 - 1b2p - 53 sqm Flat 8 - 2b4p - 73 sqm Flat 9 - 3b6p - 140sqm

Page 69

